

## Zoning Administrator Agenda Report

Meeting Date 07/11/2017

File: UP 17-10

**DATE:** June 15, 2017

**TO:** ZONING ADMINISTRATOR

**FROM:** Shannon Costa, Assistant Planner, 879-6506

RE: Use Permit 17-10 (Enloe Medical Center Parking Lot)

226 W 5<sup>th</sup> Avenue; (APN 003-023-008, portion)

## RECOMMENDATION

Planning staff recommends that the Zoning Administrator find that the project is categorically exempt from environmental review and approve Use Permit 17-10 (Enloe Medical Center Parking Lot) subject to the findings and recommended conditions of approval in this report.

## **BACKGROUND AND ANALYSIS**

This is a request to allow a standalone off-site parking area on a parcel located within the Enloe Medical Center campus. The site is located west of the Esplanade, between West 5<sup>th</sup> Avenue and West 6<sup>th</sup> Avenue (see Location Map, **Attachment A** and **Attachment B**, Plat to Accompany Use Permit 17-10). The subject site is designated Public Facilities and Services on the General Plan diagram, and is in the PQ-SD4 (Public Quasi with Special Design Considerations West Avenues Neighborhood overlay) zoning district.

The proposal includes the construction of an approximately 20,000 square foot parking lot with approximately 66 spaces and associated landscaping (see **Attachment C**, Landscape Construction Plans). The proposed parking area has been designed in accordance with the requirements of CMC Section 19.70.060 (Design and development standards for off-street parking).

## DISCUSSION

Pursuant to Chico Municipal Code 19.70.060.H, the use of a parcel for off-site parking is permissible subject to use permit approval and in accordance with off-site location requirements. Location requirements have been satisfied, including that the off-site parking area is within 500 feet of the intended user (Enloe Medical Center) and safe pedestrian access from the parking area to the building is provided. Further, a condition of approval has been included that the applicant shall provide evidence as deemed satisfactory by the Zoning Administrator that a long-term lease or other binding agreement can be recorded that would guarantee that the parcel containing the main use (Enloe Medical Center) has an irrevocable right to utilize the parking lot.

## Site Design

Vehicle access to the parking lot is via two entry drives from West 5<sup>th</sup> Avenue. The landscape plan calls for a variety of plant species, predominately those with low water demands (see

Use Permit 17-10 (Enloe Medical Center Parking Lot)
Page 2 of 4

**Attachment D**, Landscape Planting Plan). Parking lot shading is estimated to reach approximately fifty-three percent at maturity, with six Chinese pistache trees providing most of the parking area shade. The tree plan identifies seventeen trees on the site for removal, none of which qualify as trees requiring mitigation or replacement pursuant to the City's Tree Preservation Regulations (CMC 16.66). Eight 14 foot LED pole-lights are proposed in planter islands and strips to provide adequate safety lighting, consistent with CMC 19.70.060.F (design and development standards for off-street parking) (see **Attachment E**, Lighting Detail).

## Approval Process

As required by the Development Agreement between the City of Chico and Enloe Medical Center (EMC) for the Enloe Medical Center Master Plan, EMC is constructing a passive park on the block between West 5<sup>th</sup> and West 6<sup>th</sup> Avenues and Magnolia and Arcadian Avenues. Park design consultation has taken place between EMC, the neighborhood, and the City of Chico. To proceed with construction of the park and parking lot, and to clean-up parcel lines that contain existing structures within the block, EMC is pursuing a boundary line modification (BLM) under a separate application. Completion of the BLM is a required condition of approval for the parking lot use permit.

## **ENVIRONMENTAL REVIEW**

The proposed use permit request is categorically exempt from the California Environmental Quality Act (CEQA) pursuant to CEQA Guidelines Section 15311 (Accessory Structures). The request involves a small parking lot accessory to a larger medical center campus.

## **PUBLIC CONTACT**

A 10-day public hearing notice was mailed to all landowners and residents within 500 feet of the site.

## **FINDINGS**

Following a public hearing, the Zoning Administrator may approve a use permit application, with or without conditions, only if all of the following findings can be made:

## Use Permit Findings

- A. The proposed use is allowed within the subject zoning district and complies with all of the applicable provisions of Chapter 19.24 (Use Permits).
  - Off-site parking as a standalone use is permissible subject to use permit approval under Chico Municipal Code Section 19.70.060. This use permit has been processed in accordance with the requirements of Chapter 19.24.
- B. The proposed use would not be detrimental to the health, safety, and general welfare of persons residing or working in the neighborhood of the proposed use.

The parking lot would address parking demand related to Enloe Medical Center operations and would alleviate demand on on-street parking in the neighborhood. Design of the parking lot satisfies off-site location requirements required by the Chico Municipal Code. Parking lot landscaping has been designed in accordance CMC 19.70.060.E and the proposed lighting provides increased safety and security. No deleterious effects of the parking lot have been identified.

C. The proposed use would not be detrimental and/or injurious to property and improvements in the neighborhood of the proposed use, as well as the general welfare of the City.

The proposed off-site parking lot would reduce on-street parking demand in the neighborhood. No deleterious effects of the parking lot have been identified.

D. The proposed entitlement is consistent with the General Plan, any applicable specific plan, and any applicable neighborhood or area plan.

The proposed use is consistent with the General Plan in that is an accessory to a principally permitted use in the Public Quasi zoning designation. The parking lot is appropriately shaded, associated landscaping creates an attractive space and it will provide off-street parking that will reduce on-street parking in the surrounding residential neighborhood. The proposed project is consistent with General Plan goals and policies to ensure that appropriate parking is provided that supports the Citywide goals for economic development and livable neighborhoods (CIRC-8, CIRC-8.1). The use of a stand-alone parking lot is compatible with the surrounding hospital campus, as well as the nearby industrial, commercial and residential uses.

E. The design, location, size, and operating characteristics of the proposed use are compatible with the existing and future land uses in the vicinity.

Implementation of development standards for off-street parking including shading, lighting, location and landscaping will ensure compatibility with surrounding commercial and residential uses.

## **CONDITIONS OF APPROVAL**

- Use Permit 17-10 (Enloe Medical Center Parking Lot) authorizes an off-site parking lot in accordance with the attached site plan entitled "Conditional Use Permit No. 17-10 (Enloe Medical Center Parking Lot)" identified as Exhibit B and in compliance with all other conditions of approval.
- 2. The permittee shall comply with all other State and local Code provisions, including those of the Building Division, Public Works, and Fire Department. The permittee is responsible for contacting these offices to verify the need for permits.
- 3. Use Permit 17-10 (Enloe Medical Center Parking Lot) is not effective until approval and

Use Permit 17-10 (Enloe Medical Center Parking Lot) Page **4** of **4** 

recordation of the boundary line modification (BLM 17-03) that reflects the newly created parcel that will support the parking lot use.

4. The applicant shall provide evidence, as deemed satisfactory by the Zoning Administrator, that a suitable long-term lease or other binding agreement can be executed and recorded which would guarantee that the parcel containing the main use or structure has an irrevocable right to utilize the identified parcel for parking.

## **DISTRIBUTION**

## Internal (3)

Zoning Administrator Brendan Vieg, Zoning Administrator Shannon Costa, Assistant Planner

## External (2)


Enloe Medical Center, Attn: Bill Seguine, 1601 Esplanade, Chico, CA 95926


CANA, Attn: John Whitehead, jockbaw@sbcglobal.net


## **EXHIBITS**

- A. Notification and Location Map
- B. Site Plan
- C. Landscape Construction Plans
- D. Landscape Planting Plans
- E. Lighting Detail

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CONSTRUCT

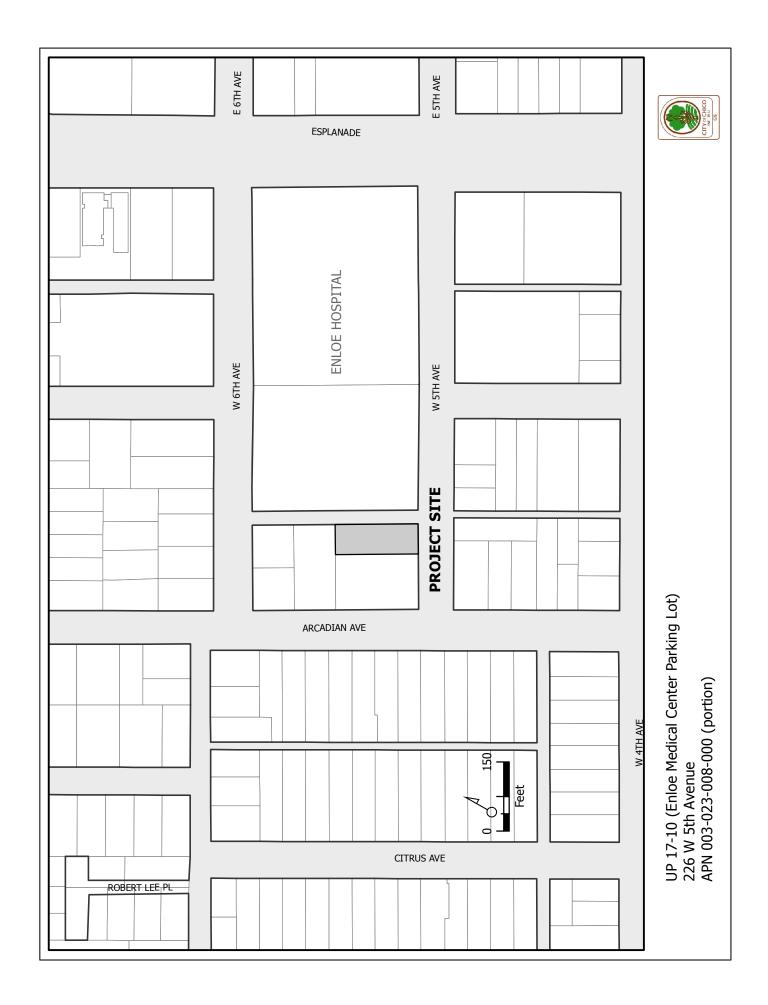NOTES
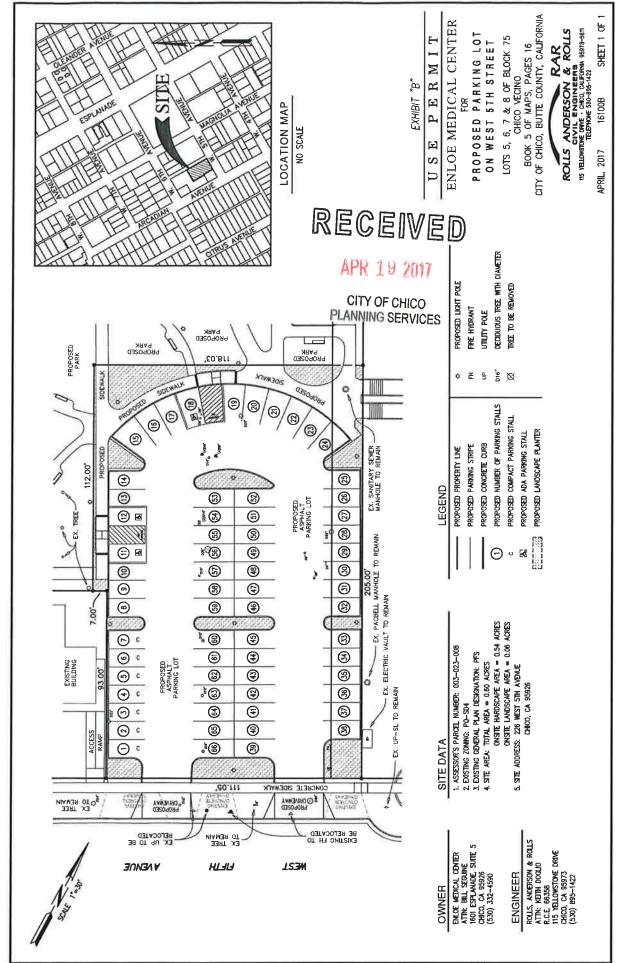
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EXISTING TREE

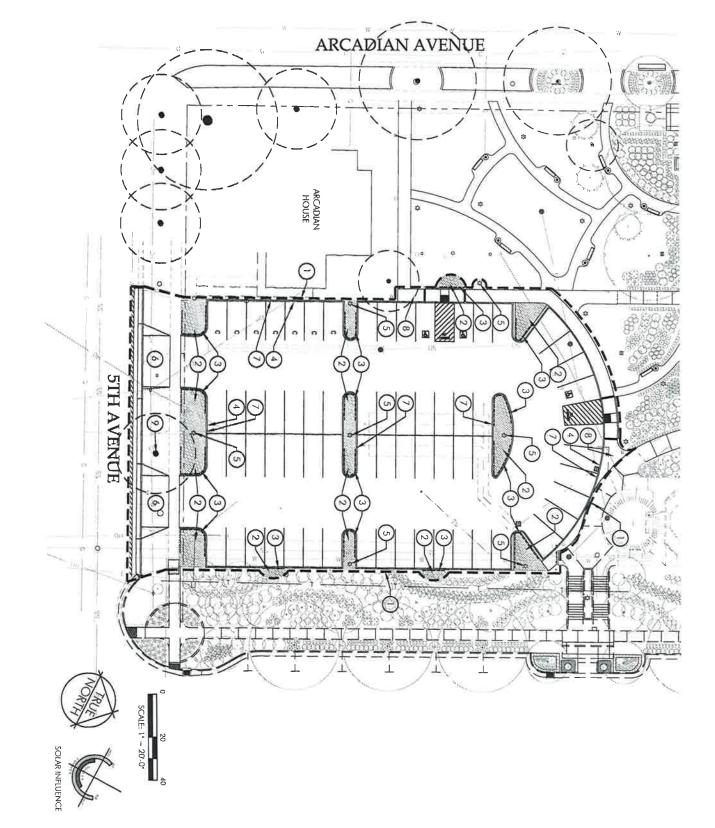NEW CONCRETE WALK

9 0

NEW CONCRETE PARKING LOT

SEE CIVIL ENGINEER'S PLANS

SEE CIVIL ENGINEER'S PLANS

SEE CIVIL ENGINEER'S PLANS

RETAIN AND PROTECT


NEW DRIVE CUT

INSTALL ALL ELEMENTS PER MANUFACTURERS' SPECIFICATIONS.

E HIS WORK WITH THE WORK OF OTHERS.

## RECEIVED

CITY OF CHICO PLANNING SERVICES JUN 15 2017

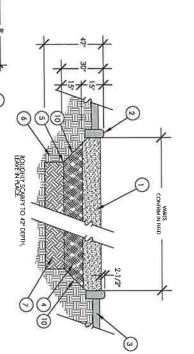

## SOIL REPLACEMENT

SCALE: NTS

SHEET NUMBER L-1.0

OBBALL FROM LAUDSCAPE ALCHITECT, IIIC 2017 ALL RIGHTS RESERVED

Dale: February 14, 2017 - 8:44 om

15" DEPTH IMPORT YOP SOIL OR SITE STRIPINGS APPROVED BY LANDSCAPE MACHIECT.

2) PARKING LOT CLUBB

3) PARKING LOT CLUBB

3) PARKING LOT PAYEMENT

4) SOIL MIX: 50% IMPORT TOPSOIL, 50% EXISTING SITE SOIL.

5) EXCAVATE TO DEPTH OF 30" OR 30" BELOW STRUCTURAL FILL, WHICHEVER IS CREATER.

6) UNDISTURBED SOIL

7) ROUGHTY SCARIFY TO 42" DEPTH, LEWIE IN PLACE

8) ADJACENT FINISH GRADE

9) CONCRETE CURB OR WALL WHERE APPLICABLE

10] 1:1 SLOPE

NOTE: COMPACT TO 85% DENSITY AND ALLOW FOR SETTLING

BFIA PROJECT #: 1924 PROJECT NUMBERS

CONSULTANT PROJECT #: NA.

PLAN

CONSTRUCTION

LANDSCAPE

MEDICAL CENTER

PARKING AREA AT ENLOE

1531 ESPLANADE CHICO, CA 95926 530-332-7429 ENLOE MEDICAL CENTER

SEE DETAILS AND CIVIL ENGINEER'S PLANS FOR A

DDITIONAL INFORMATION

DSCAPE ARCHITECT PRIOR TO CONSTRUCTION. JLATIONS PERTAINING TO THIS PROJECT.

CLIENT


WITHIN PROJECT SITE PRIOR TO EXCAVATION, THE CONTRACTOR IS DAMAGE TO ALL EXISTING UTILITIES.







TYPICAL SYMBOLMATCH EXISTING MODEL INSTALLED AT THE PARK AREA. ACCULITE LA SERIES, FINIEA AREA LIGHT, MODEL:
LA-B06-5K-E1-P-45-PC-PG, CONTRACTOR IS RESPONSIBLE FOR ELECTRICAL DESIGN, FOOTING DESIGN, AND CONNECTING TO THE EXISTING LIGHTING SYSTEM AT THE PARK,

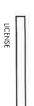



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CONSTRUCTIO

LEGEND

REMARKS

DETAILS

TYPICAL SYMBOL

TYPICAL SYMBOL

LIMIT OF WORK

SOIL REPLACEMENT

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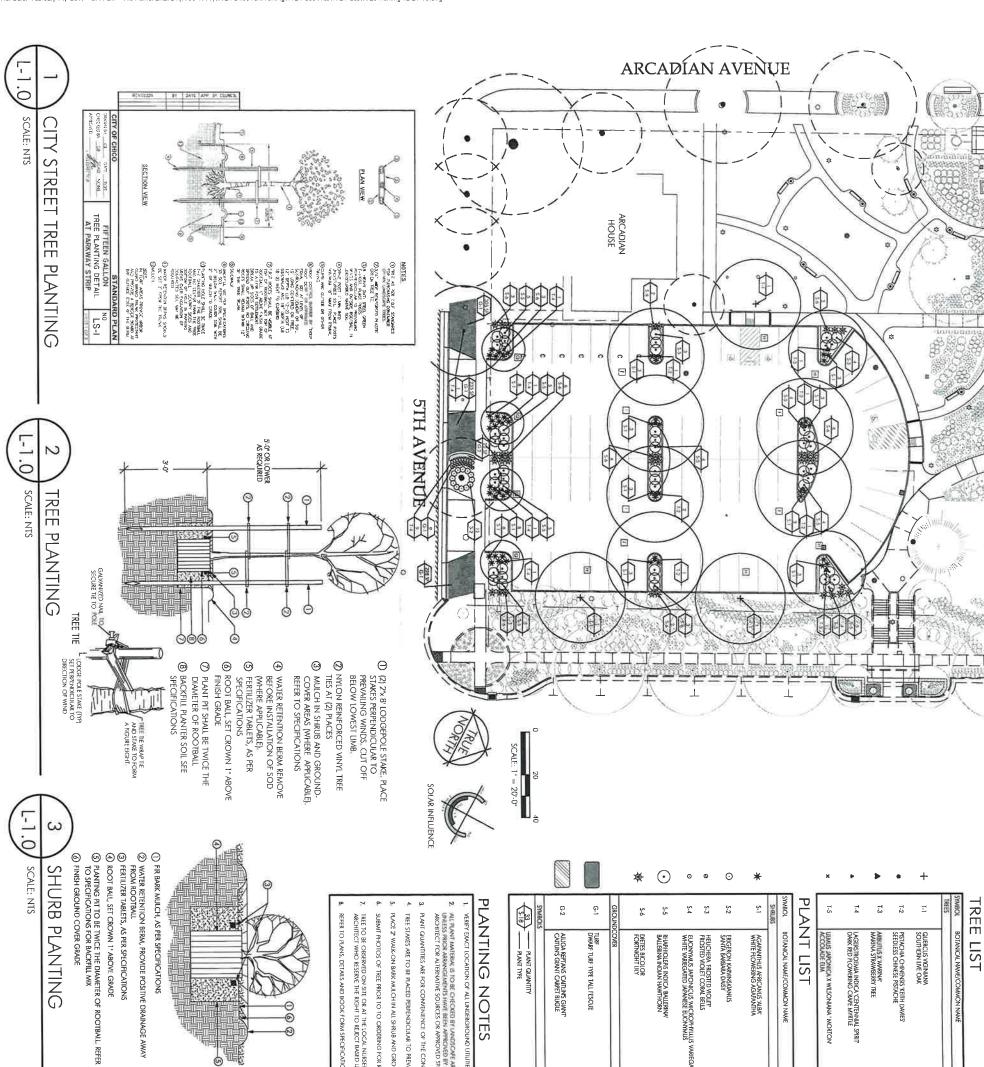
ROOT BARRIER

DEEPROOT MODEL UB-18 OR EQUAL, INSTALL IN ACCORDANCE WITH MANUFACTURER'S INSTRUCTIONS

TYPICAL SYMBOL, SEE SHEET L-2.0 FOR INTERIOR PARKING LOT AND TREE SHADE CALCULATIONS.

DELINEATION OF PARKING LOT AREA FOR USE IN DETERMINING PERCENTAGE OF PARKING LOT LANDSCAPE AND TREE SHADE

PARKING LOT AREA LIGHTS



## TREE LIST

1	ROTANICAI NAME/COMMON NAME	SIZE	RINAUG	QUANTITY REMARKS
T				
i i	QUERCUS VIGINIANA	46' BOX	ω	matching, multi-trunked. See Detail 2, this sheet
	SOUTHERN LIVE COX			
	PISTACHIA CHINENSIS KEITH DAVIES SEEDLESS CHINESE PISTACHE	15 GAL	6	1° MIN CALIPER STANDARD, SEE DETAIL 2, THIS SHEET
	ARBUTUS X: MARINA MARINA STRAWBERRY TREE	24' BOX	2	1º MIN CALIPER STANDARD SEE DETAIL 2, THIS SHEET
	JAGERSTROEMA INDICA "CENTENNIAL SPRIT DAKK RED FLOWERING CRAPE MYRTLE	24' BOX	4	MULTI-TRUNKED. SEE DETAIL 2, THIS SHEET
	UUMUS JAPONICA X WILSONIANA" MORTON" ACCOLADE ELM	15 GAL	2	STANDARD. SEE DETAIL 1, THIS SHEET
ı	-			

## PLANT LIST

SYMBOL	BOTANICAL NAME/COMMON NAME	SIZE	QUANTIT	QUANTITY REMARKS
SHILINES				
\$:1	AGAPANTHUS AFRICANUS 'ALBA' WHITE FLOWERING AGAPANTHA	1 GAL	51	PLANT AS PER DETAIL 3, THIS SHEET
5-2	ERIGERON KARVINSKIANUS SANTA BARBARA DAISY	1 GAL	12	PLANT AS PER DETAIL 3, THIS SHEET
S-3	HEUCHERA FROSTED VIOLET FROSTED VIOLET CORAL BELLS	1 GAL	9	PLANT AS PER DETAIL 3, THIS SHEET
S.A	EUONYMUS JAPONICUS 'MICROPHYLLUS VARIEGATUS' WHITE VARIEGATED JAPANESE EUONYMUS	1 GAL	9	PLANT AS PER DETAIL 3, THIS SHEET
Ş-5	RHAPHOLEPS INDICA BALLERINA BALLERINA INDIAN HAWTHORN	5 GAL	48	PLANT AS PER. DETAIL 3, THIS SHEET
<b>5</b> -6	DIETES BICOLOR FORTNIGHT LLY	1 GAL	34	PLANT AS PER DETAIL 3, THIS SHEET
GROUNDCOVER	COVER			
6.	TURF DWARF TURF TYPE TALL FESCUE	SOB	@768 SF	SEE BOOK FORM SPECIFICATIONS
G-2	AUGA RETTANS CATTUNS GIANT CATTUNS GIANT CARPET BUGLE	1 GAL	@23 SF	PLANT @ 12" O.C. TRIANGULAR SPACING, SEE BOOK FORM SPECIFICATIONS
\$YMBOIS (\$.18)	PLANT QUANTITY  PLANT TYPE			

 $\odot$ 0

VERIFY EXACT LOCATION OF ALL UNDERGROUND UTILITIES PRIOR TO CO R TO INSTALLATION. NO SUBSTITUTIONS FOR FLANT IMMERIAL WILL BE ALLOWED ICHTECT. IN THE EVENT OF FLANT IMMERIAL UNAVAILABILITY, CONTACT LANDSCAPE JITON, SEE BOOK FORM SPECIFICATIONS.

PLANTING NOTES

- PLANT QUANTITIES ARE FOR CONVENIENCE OF THE CONTRACTOR, CONTRACTOR TO CONFIRM EXACT NUMBER.
- PLACE 2" WALK-ON BARK MULCH IN ALL SHRUB AND GROUNDCOVER AREAS, SEE BOOK FORM SPECIFICATIONS TREE STAKES ARE TO BE PLACED PERPENDICULAR TO PREVAILING WINDS. REMOVE NURSERY STAKES, REPLACE WITH STAKES PER DETAIL
- TREE TO BE OBSERVED ON SITE OR AT THE LOCAL NURSERY, PRIOR TO F ARCHITECT WHO RESERVE THE RIGHT TO REJECT BASED UPON DEFECTS SUBMIT PHOTOS OF TREE PRIOR TO TO ORDERING FOR REVIEW AND PRELIMINARY APPROVAL BY FACILITIES DIRECTOR

REFER TO PLANS, DETAILS AND BOOK FORM SPECIFICATIONS FOR ADDITIONAL INFORMATION.

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## JUN 15 2017

## CITY OF CHICO PLANNING SERVICES PARKING LOT LANDSCAPE

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## SHADE CALCULATIONS

SCRIPTION	AREA	PERCENT
ARKING LOT PAVING	20,648 SF	
ARKING LOT LANDSCAPE	1219 SF	5%

c	DESCRICA	SHAUE AKEA	MANNIT	OIA	PERCEIVE
	TOTAL PARKING AND BACK-UP AREA	ACK-UP AREA		20,649 SF	
	SHADE AREA PROVIDEO				
	40 DIAMETER				
	FULL	1,256 SF	6	7,536 SF	36%
_	THREE QUARTER	942 SF	0	0	0
1	HALF	628 SF	5	3,140 SF	15%
υ	QUARTER	314 SF	0	0	0
	20 DIAMETER				
n	FULL	314 SF	0	0	0
	THREE QUARTER	367 SF	0	0	0
ì.	HALF	157 SF	0	0	0
0	QUARTER	78 SF	_	312 SF	*
					7000

DIVERSIVE SUCCESSIVE VICE OF STREET, THE STREET, THE STREET, S

TOTAL SHADE AREA PROVIDED

BFIA PROJECT #: 1924
CONSULTANT PROJECT # NA.

PROJECT NUMBERS

REVIEW SUBMITTAL

LANDSCAPE PLANTING PLAN

SHEET TITLE

PARKING AREA AT ENLOE MEDICAL CENTER

PROJECT

1531 ESPLANADE CHICO, CA 95926 **ENLOE MEDICAL** 530-332-7429 CENTER

CLIENT


CONSULTANT






LICENSE

BRIAN FIRTH
LANDSCAPE
ARCHITECT, INC.
627 BROADWAY, SUITE 220,
CHICO, CAUFORNIA 95978 PHONE (530) 899 1130/ FAX: (530) 899 1920

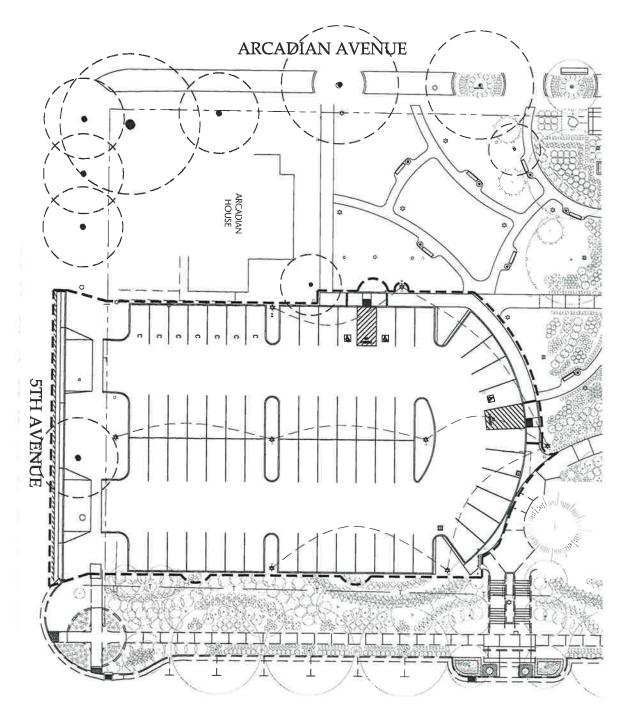

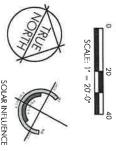

> 1	TYPE MANU	
	MANUFACTURER	
LA-B06-5K-E1-P-4S-PC-PG	CATALOG NUMBER	LIGHT FIXTURE SCHEDULE
	DESCRIPTION	SCHEDULE
1	LAMPS	
POLE	MOUNTING	

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Flot Date: Fabriary 14, 2017 - 8-45 am
PROJECT NUMBERS BFIA PROJECT #: 1924 CONSULTANT PROJECT # NA.

CITY OF CHICO PLANNING SERVICES

JUN 15 2017

SHEET TITLE

LANDSCAPE

LIGHTING

PLAN

PARKING AREA AT ENLOE MEDICAL CENTER


ENLOE MEDICAL CENTER 1531 ESPLANADE CHICO, CA 95926 530-332-7429



CONSULTANT

LICENSE

BRIAN FIRTH
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ARCHITECT, INC.
627 BROOWNE, SUITE 220.
CHICO CAIFORNA 95728
PHONE: 5309 899-1130/
PHONE: 6309 899-120/
www. BFLAdesign.com/
www. locabook.com/BFLAdesign.

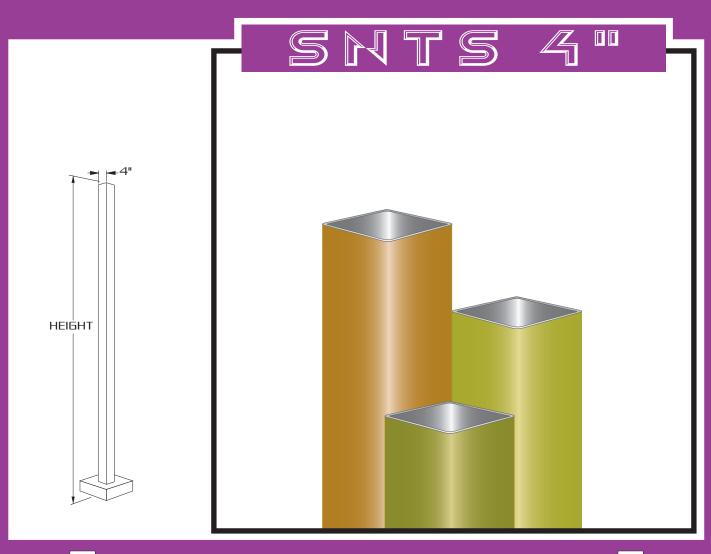



## **SPECIFICATIONS**

- SHAFT: 4" SQUARE, FABRICATED FROM HIGH GRADE STRUCTURAL STEEL TUBE. SHAFT CONFORMS TO ASTM-A-501-68 SPECIFICATIONS. MEETS OR EXCEEDS MINIMUM YIELD STRENGTH OF 46,000 P.S.I. WALL THICKNESS 11 GA. (.120 WALL)OR 7 GA. (.180 WALL) AS SPECIFIED. REINFORCED HAND HOLE IS FURNISHED WITH COVER. SHAFT IS FURNISHED WITH GROUND LUG LOCATED INSIDE POLE ON WALL OPPOSITE HAND HOLE.
- BASE PLATE: FABRICATED FROM STRUCTURAL QUALITY HOT ROLLED STEEL. MEETS OR EXCEEDS MINIMUM YIELD STRENGTH OF 36,000 P.S.I. BASE TELESCOPES AND IS CIRCUMFERENTIALLY WELDED TO POLE SHAFT. SLOTTED BOLT HOLES PROVIDE 1" FLEXIBILITY ON EITHER SIDE OF BOLT CIRCLE CENTERLINE.
- ANCHORAGE: [4] ANCHOR BOLTS FABRICATED FROM HOT ROLLED STEEL BAR, MINIMUM YIELD STRENGTH OF 50,000 P.S.I. BOLTS HAVE "L" BEND ON ONE END AND ARE THREADED ON THE OTHER END. BOLTS ARE FULLY GALVANIZED AND ARE FURNISHED WITH TWO NUTS AND TWO WASHERS.
- BASE COVER: FABRICATED FROM HEAVY GAUGE QUALITY CARBON STEEL. TWO PIECE COVER CONCEALS BASE.
  - FINISH: POLYESTER POWDER COAT. THE METAL SURFACE IS PRETREATED BY SAND BLAST PROCESS FOR MAXIMUM PAINT ADHESION. ELECTROSTATICALLY APPLIED POLYESTER POWDER TOPCOAT IS BAKED AT 400° TEMPERATURE FOR MAXIMUM HARDNESS AND EXTERIOR DURABILITY.





# **D-Series Pole Mount** LED Area Luminaire

Catalog Number

Notes

Type

## lighting facts















## **Specifications** Luminaire

Width: EPA: Length:



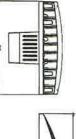

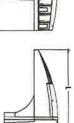

Introduction

features a sleek, modern design and is carefully engineered to provide long-lasting, energy-efficient lighting with a variety of optical and control options for customized integrated LED solution for area and site applications. It The D-Series Pole Mount luminaire is a stylish, fully

use and up to 74% in energy savings over comparable 250W metal halide luminaires, the D-Series Pole Mount is a reliable, low-maintenance lighting solution that produces With an expected service life of over 20 years of nighttime

Weight: Height:

# performance.

DSXWPM LED

DSXWPM LED

\$		erir erir	± +
200	<u> </u>	9	8" (20.3 cm) 16.03 lbs (7.3 kg)
10 LEDs (one engine) 20 LEDs (two engines)		nformati	8" bs kg)
350 530 700 1000		9	T
350 350 mA 530 530 mA 700 700 mA 1000 1000 mA (1A)	Cuterio .	-	*
30K 40K 50K AMBPC	Color ten		
3000K 4000K 5000K Amber phosphor converted	nperature	D.	
125 12M 13S 13M 14M 1FTM	Distribu	KAMP	
lype II short Type II medium Type II short Type III short Type III medium Type IV medium Type IV medium Forward throw medium		LE: DSXWPM	
T5M T5S T5A T5W ASYDF SYMDF		LED 200	250W r a reliak sites th
Type V medium Type V short Type V area Type V wide Asymmetric diffuse Symmetric diffuse		C 1000 40K T5N	250W metal halide luminaires, the D-Sa a reliable, low-maintenance lighting so sites that are exceptionally illuminated
MVOLT <sup>1</sup> 120 <sup>1</sup> 208 <sup>1</sup> 240 <sup>1</sup> 277 <sup>1</sup> 347 <sup>2</sup> 480 <sup>2</sup>	Voltega	MVOL	aires, the C ce lighting ly illumina
Shipped included  SPUMBA Square pole universal mounting adapter  RPUMBA Round pole universal mounting adapter  PUMBA Square and round universal mounting adapter	Meanting!	EXAMPLE: DSXWPM LED 20C 1000 40K T5M MVOLT SPUMBA DDBXD	250W metal halide luminaires, the D-Series Pole Mount is a reliable, low-maintenance lighting solution that produces sites that are exceptionally illuminated.

## PAR DMG Shipped installed Photoelectric cell, Motion/ambient I 0-10V dimming d

	Only 1				Finish irroun	med:		TISSING WEST
installed	Shippe	Shipped installed	Shippo	Shipped separately 9	DDBXD	Dark bronze	DDBTXD	DDBTXD Textured dark bronze
Photoelectric cell, button type *	₩	Single fuse (120, 277, 347V) *	BSW	BSW Bird-deterrent spikes	OBLXO	Black	DBLBXD	Textured black
0-10V dimming driver (no controls)	PF -	Double fuse (208, 240, 480 V) *	₩G	WG Wire guard	DNAXD	Natural aluminum	DNATXD	Textured natural aluminum
Motion/ambient light sensor, < 15° mtg ht 56	<b>E</b>	House-side shield a	8	Vandai guard	DWHXD	White	DWHGXD	DWHGXD Textured white
Motion/ambient light sensor, 15-30' mtg ht 56			DD.	DDL Diffused drop lens	DXSXD	Sandstone	DXTSSO	DSSTXD Textured sandstone
Motion/ambient servor, 8–15' mounting height, ambient servor enabled at 162'								
<ul> <li>Morton/ambient sensor, 15-30' mounting height, ambient sensor enabled at 162'</li> </ul>								

PIRTIFGV

PIRH1FGV Motion/ambient sensor et

NOTES

NO

DSXWISSW U DSXWIWG U DSXWIWG U D SALMXSQ

Wire guard accessory
Vandai guard accessory Diffused drap lens

Accessories
Ordered and shipped separately.

House-side shield (one per light engine) Bird-deterrent spilos



One Lithonia Way • Conyers, Georgia 30012 • Phone: 800.279.8041 • Fax: 770.918.1209 • © 2013-2016 Acuity Brands Lighting, Inc. All rights reserved.

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