

Meeting Date 04/21/2021

DATE: April 8, 2021 File: AR 21-03

TO: Architectural Review and Historic Preservation Board

FROM: Kelly Murphy, Planner. 530-879-6535, kelly.murphy@chicoca.gov

RE: Architectural Review 21-03 (B20 Mixed Use Project); 1993 Bruce Road, APN 018-

390-021

### RECOMMENDATION

Staff recommends that the Architectural Review and Historic Preservation Board adopt the required findings contained in the agenda report and approve the proposed project, subject to the recommended conditions.

### **Proposed Motion**

I move that the Architectural Review and Historic Preservation Board adopt the required findings contained in the agenda report and approve Architectural Review 21-03 (B20 Mixed Use Project), subject to the recommended conditions therein.

### **BACKGROUND**

The applicant proposes to construct a new vertical mixed-use project on an undeveloped 2.5-acre site located on the northeast corner of Bruce Road and E. 20th Street at 1993 Bruce Road (see **Attachment A**, Location Map). The site is designated Neighborhood Commercial on the City of Chico General Plan Land Use Diagram and zoned CN (Neighborhood Commercial).

The proposed project is comprised of a three-story, L-shaped building with a footprint of 20,469 square feet, containing 60 affordable senior housing units and three commercial suites with approximately 10,000 square feet of commercial space (see **Attachment B**, Project Description and **Attachment C**, Site Plan). The site is currently vacant. Surrounding land uses include residential uses to the north and east and vacant land to the west and south.

### **ANALYSIS**

Residential units would include 52 one-bedroom units and 8 two-bedroom units. Multi-family residential uses are allowed in the CN zoning district on the second floor and above. A use permit is required for ground-level occupancy, except for accessible units required by the Building Code, which are allowed by right. Per California Building Code 1102A.3.1, at least 10-percent of multi-story dwellings in apartment buildings are required to be accessible. The project proposes 6 accessible units on the ground floor, consistent with these requirements.

The residential density range allowed in the CN zoning district is 6 to 22 dwelling units per gross acre. The project parcel has a net area of 2.5 acres and a gross area of 3.46 acres, allowing up to 76 dwelling units. The project proposes a total of 60 units, within the allowable density range for the CN zone.

Pursuant to Chico Municipal Code 19.44.020 Table 4-6, the CN zoning district allows for a variety of retail uses, per the following area constraints:

- Drug stores/pharmacies 4,000s.f. or less
- Furniture, furnishings, and equipment, 2,500s.f. or less
- Grocery stores, 4,000s.f. or less
- Retail stores general merchandise, 2,500s.f. or less

Additional allowed land uses include restaurants less than 5,000 square feet, and service uses such as financial, medical, and professional offices.

Commercial suites accommodating retail, office and service uses would be located on the ground floor of the building fronting Bruce Road (see **Attachment D**, Floor Plan). Suites 2 and 3 would be connected via a breezeway, enhancing pedestrian access and circulation from Bruce Road to the site's interior. A variety of other features associated with the residential aspect of the project would be located on the first floor, including a community room, fitness room, utility room, communal kitchen, office and storage space. The second and third floors of the building would be dedicated to residential units.

In addition to several indoor amenities, senior residents would enjoy outdoor community-centered spaces including a dog park, fenced garden area, bocce court and patio. The commercial suites also benefit from designated outdoor terraces.

### **Parking**

Pursuant to CMC Section 19.70.040, senior housing projects are required to provide one offstreet parking space per every two dwelling units, of which half shall be covered. The residential component of the project proposes a total of 60 affordable multi-family senior housing units, requiring at least 30 off-street vehicle parking spaces. The project would provide 36 parking spaces for the residential use in a separate parking array along the northern property line, 15 of which would be covered. This parking area has two access points, one from Bruce Road and one from Belgium Avenue, and a designated drop-off area for senior residents.

The commercial parking area would provide an additional 66 off-street parking spaces accessible from Belgium Avenue. The number of vehicle parking spaces required for specific uses is subject to CMC Section 19.70.040. Restaurant parking is calculated at a rate of one space per 94 square feet of customer floor area, including outside dining. Certain retail and service uses, as specified on the site plan, are required to provide one space per every 375 square feet of gross floor area. The project has accounted for 4,606 square feet of restaurant floor area (resulting in 49 required parking spaces), and 6,300 square feet of gross floor area for retail and service uses (resulting in 17 required parking spaces).

Both parking areas will include shade canopies supporting photoelectric solar panels. Per CMC 19.60.100, if solar collectors are proposed for any new development, exterior surfaces of the collectors and related equipment shall have a matte finish and shall be color-coordinated to harmonize with the materials and other dominant colors of the structure. As noted on the site plan, the project proposes a matte finish in Color 'A' "Dovetail", consistent with the stucco color on the building.

Covered bicycle parking is proposed under the breezeway between commercial suites two and three, while additional uncovered bike parking is located interior to the site near the entrance to commercial suite two. The project proposes a total of ten bicycle parking spaces, meeting requirements. Existing eight-foot wide sidewalks along Belgium would be continued along the project's east side to 20<sup>th</sup> Street, encouraging pedestrian and bicycle circulation. The existing transit stop on Bruce Road would be enhanced with a bus pullout pocket, further improving access to and from the site.

### **Architectural Design**

The project complies with all development standards including lot size, site coverage, setbacks and building height. The proposed three-story, wood-framed structure would reflect a sleek, modern architectural design with a neutral color palette using shades of gray and beige stucco, accented by vertical metal panels and trim in an inky blue and horizontal metal panels and trim in a red cedar finish (see **Attachment E**, Color Elevations/Colors and Materials and **Attachment F**, Color Renderings). Elevations have been enlivened with balconies, masses with a variety of planes, heights, materials and colors. The design does well in differentiating upper floor residential units from the ground level commercial spaces and drawing the eye to particular locations of focus. The structure would have a height of 35 feet and a flat roof with both corniced and simple parapets extending to 41 feet, consistent with building height requirements for the CN zoning district. The project also proposes a covered CMU trash enclosure utilizing colors and materials to match the building.

In addition to the photovoltaic panels atop carports and on the roof of the building, "green" design features include energy-efficient appliances, high-efficiency plumbing fixtures, double pane windows, radiant barriers, energy saving light fixtures, tankless water heaters, zero VOC interior paint, low VOC adhesives and sealants, and ceiling fans.

### Lighting and Landscaping

The building is arranged to provide areas for residents to recreate in various capacities, including a bocce ball court, patio space and a fenced garden with raised planter boxes and fruit trees. The landscape plan proposes a variety of native and drought tolerant trees and plants (see **Attachment G**, Landscape Plan). A total of 64 new trees would be planted onsite, including oak, pistache, maple, palm and elm trees. A selection of shrubs having vibrant colors would be planted near building entrances and along the street frontage, further enhancing the aesthetic appeal of the site. Parking lot shading is estimated by the landscape architect to reach 50 percent at tree maturity, with the solar-equipped carport structures also contributing to this calculation consistent with CMC Section 19.70.60.E(2). Exterior lighting would include twelve parking lot lights with a finished height of 14 feet, wall-mounted downlights, downlighting on the underside of the solar canopies, recessed downlights in the covered breezeway areas and pathway lighting (see **Attachment H**, Lighting Details).

### DISCUSSION

### General Plan Goals, Policies and Actions

The Neighborhood Commercial land use designation accommodates a mix of business, office, and residential uses that support the needs of residents living in the surrounding neighborhoods. The project is consistent with several policies and actions under Land Use (LU) Goals LU-2 and LU-4 to promote compatible infill development that includes a mix and

distribution of uses, as it would provide missing neighborhood elements such as retail, enhanced architectural quality, and circulation improvements for pedestrians, bicycles and vehicles (Action LU-2.3.3 and LU-2.3.4; Policy LU-2.4, LU-4.2 and LU-4.4). Goal LU-3 of the General Plan is to enhance existing neighborhoods with walkable access to recreation, places to gather, jobs, daily shopping needs, and other community services. The project is consistent with policies developed under this goal to encourage the development of complete neighborhoods and neighborhood serving centers with a mix of land uses intended to reduce auto trips and support walking, biking and transit use (Policy LU-3.1 and LU-3.2).

The project design includes several energy efficient features and solar canopies in the parking area, consistent with Sustainability Policy SUS-5.2, and implements Community Design (CD) Policy 3.1 (Lasting Design and Materials), Policy 3.2 (Bicycle and Pedestrians) and Goal CD-5 (Compatible Infill Development). Additionally, the project is consistent with goals and policies of the Housing Element to encourage the creation of housing for persons with special needs (H.4), promote a mix of dwelling types and sizes throughout the City (H.3.3), and provide housing that is affordable for individuals and families with low incomes (H.2.1).

### Consistency with Design Guidelines Manual

The Mixed-Use Neighborhood Commercial project type accommodates businesses, institutions, and service organizations serving the daily needs of nearby residents. Consistent with this project type, the proposed development would accommodate retail, small-scale financial, business, and personal services, and small-scale restaurant uses on the ground floor, with residential units above. The project is consistent with several Design Guidelines (DGs), including those that call for screening parking views from the public street, providing pedestrian and bicycle amenities, and attractive architecture that creates a sense of place.

A pedestrian-friendly environment is achieved by placing the building near the public sidewalk and existing bus stop on Bruce Road (DGs 1.1.13 and 1.1.15) and providing covered and uncovered bicycle parking, wide sidewalks, pedestrian crossings and public transit options to/from the site (DGs 2.1.21, 2.1.22, 2.1.23, 2.1.24, 2.1.31, 2.1.32 and 4.2.14). The building uses appropriate massing, fenestration, articulation and materials (DG 2.2.11), incorporates varied building depth and shadow (DGs 2.2.22 and 2.2.31), and offers continuity throughout all four elevations in both colors and materials (DGs 1.2.22 and 3.2.33).

Parking views are minimized with landscaping and by locating vehicle parking interior to the site (DGs 1.1.14, 2.1.25, 2.1.26 and 2.1.27). Building entrances are well defined by awnings and wall recesses (DGs 2.2.23 and 2.2.24), lending to easy wayfinding for residents and visitors (DG 4.1.31). Pedestrians are provided easy access to common spaces (DG 4.1.42) and covered, shaded area under the breezeway connecting the building wings (DG 2.1.35).

### REQUIRED FINDINGS FOR APPROVAL

### **Environmental Review**

The project has been determined to be categorically exempt under CMC Section 1.40.220 and pursuant to the California Environmental Quality Act (CEQA) Guidelines Section 15332 (In-Fill Development Projects). Consistent with this exemption, the project is: consistent with the applicable General Plan designation, zoning regulations, and General Plan policies; is less than five acres in size, substantially surrounded by urban uses; has no habitat value for special status species; will not result in any significant impacts regarding traffic, noise, air quality, or

water quality; and can be adequately served by all required utilities and public services.

### **Architectural Review**

According to Chico Municipal Code Section 19.18.060, the Architectural Review and Historic Preservation Board shall determine whether or not a project adequately meets adopted City standards and design guidelines, based upon the following findings:

1. The proposed development is consistent with the General Plan, any applicable specific plan, and any applicable neighborhood or area plans.

The proposal is consistent with several General Plan goals and policies, including those that encourage architectural designs that promote compatible infill development that includes a mix and distribution of uses and encourage the development of complete neighborhoods and neighborhood serving centers with a mix of land uses intended to reduce auto trips and support walking, biking and transit use (Goals LU-2, LU-3 and LU-4; Policies LU-2.4, LU-3.1, LU-3.2, LU-4.2 and LU-4.4; Actions LU-2.3.3, LU-2.3.4).

The project design includes energy efficient features and solar canopies in the parking area, consistent with Sustainability Policy SUS-5.2, and implements Community Design (CD) Policy 3.1 (Lasting Design and Materials), Policy 3.2 (Bicycle and Pedestrians) and Goal CD-5 (Compatible Infill Development). Additionally, the project is consistent with several goals, policies, and actions of the Housing Element (Goal H-4; Actions H.3.3 and H.2.1). The site is not located within the bounds of a Neighborhood Plan or area plan.

2. The proposed development, including the character, scale, and quality of design are consistent with the purpose/intent of this chapter and any adopted design guidelines.

A pedestrian-friendly environment is achieved by placing the building near the public sidewalk and existing bus stop on Bruce Road (DGs 1.1.13 and 1.1.15) and providing covered and uncovered bicycle parking, wide sidewalks, pedestrian crossings and public transit options to/from the site (DGs 2.1.21, 2.1.22, 2.1.23, 2.1.24, 2.1.31, 2.1.32 and 4.2.14). The building uses appropriate massing, fenestration, articulation and materials (DG 2.2.11), incorporates varied building depth and shadow (DGs 2.2.22 and 2.2.31), and offers continuity throughout all four elevations in both colors and materials (DGs 1.2.22 and 3.2.33). Parking views are minimized with landscaping and by locating vehicle parking interior to the site (DGs 1.1.14, 2.1.25, 2.1.26 and 2.1.27). Building entrances are well defined by awnings and wall recesses (DGs 2.2.23 and 2.2.24), lending to easy wayfinding for residents and visitors (DG 4.1.31). Pedestrians are provided easy access to common spaces (DG 4.1.42) and covered, shaded area under the breezeway connecting the building wings (DG 2.1.35).

3. The architectural design of structures, including all elevations, materials and colors are visually compatible with surrounding development. Design elements, including screening of equipment, exterior lighting, signs, and awnings, have been incorporated into the project to further ensure its compatibility with the character and uses of adjacent development.

The proposed mixed-use project represents an opportunity for a development that would be neighborhood-serving and provide missing neighborhood elements such as

retail, restaurant, or office space, as well as contribute towards senior housing needs. The materials and colors of the new building, complemented by vibrant and diverse landscaping, will create an attractive development on a prominent corner site at the intersection of two main streets. The project has been conditioned to ensure that all exterior equipment will be properly screened from view by roof parapets and screen walls. All exterior lighting shall be shielded and directed downward to avoid spillage onto adjacent properties, while providing sufficient onsite lighting.

4. The location and configuration of structures are compatible with their sites and with surrounding sites and structures, and do not unnecessarily block views from other structures or dominate their surroundings.

The proposed structure is consistent with the development standards for main buildings in the CN zoning district and would be compatible with the scale and design of surrounding development, which includes the three-story Willow Oak Villas apartments to the north. Though land west and south of the project site has not yet been developed, the building will not unnecessarily block views or dominate its surroundings. Rather, the project will accommodate both existing and future development in the surrounding area by providing neighborhood serving elements such as retail, office and/or restaurant uses.

5. The general landscape design, including the color, location, size, texture, type, and coverage of plant materials, and provisions for irrigation and maintenance, and protection of landscape elements, have been considered to ensure visual relief, to complement structures, and to provide an attractive environment.

The proposed landscaping will provide a variety of seasonal color, while minimizing irrigation demands. Native plantings are appropriately located to ensure visual relief and provide an attractive environment around the new building. Appropriate attention is given to areas surrounding outdoor amenities, including a bocce court and fenced garden area with raised planter boxes and fruit trees for residents as well as outdoor terraces and patio space for commercial tenants and customers. A total of 64 new trees would be planted onsite and a selection of shrubs having vibrant colors would be planted near building entrances and along the street frontage, enhancing the aesthetic appeal of the site.

### RECOMMENDED CONDITIONS OF APPROVAL

- The front page of all approved building plans shall note in bold type face that the project shall comply with Architectural Review 21-03 (B20 Mixed Use Project). No building permits related to this approval shall receive final approval without prior authorization of Community Development Department Planning staff.
- All development shall comply with all other State and local Code provisions, including those of the City of Chico Community Development and Public Works Departments. The permittee is responsible for contacting these offices to verify the need for compliance.
- 3. All approved building plans and permits shall note that wall-mounted utilities and roof or wall penetrations, including vent stacks, utility boxes, exhaust vents, gas meters and similar equipment, shall be screened by appropriate materials and

colors. All parapet caps and other metal flashing shall be painted, consistent with the approved building colors. Adequate screening shall be verified by Planning staff prior to issuance of a certificate of occupancy.

- 4. All exterior lighting shall be shielded and directed downward to avoid light spillage onto adjacent properties.
- 5. Consistent with CMC 19.60.100, if solar collectors are proposed for any new development, exterior surfaces of the collectors and related equipment shall have a matte finish and shall be color-coordinated to harmonize with the materials and other dominant colors of the structure.
- 6. All new electric, telephone, and other wiring conduits for utilities shall be placed underground in compliance with CMC 19.60.120.
- 7. The applicant shall defend, indemnify, and hold harmless the City of Chico, its boards and commissions, officers and employees against and from any and all liabilities, demands, claims, actions or proceedings and costs and expenses incidental thereto (including costs of defense, settlement and reasonable attorney's fees), which any or all of them may suffer, incur, be responsible for or pay out as a result of or in connection with any challenge to or claim regarding the legality, validity, processing or adequacy associated with: (i) this requested entitlement; (ii) the proceedings undertaken in connection with the adoption or approval of this entitlement; (iii) any subsequent approvals or permits relating to this entitlement; (iv) the processing of occupancy permits and (v) any amendments to the approvals for this entitlement. The City of Chico shall promptly notify the applicant of any claim, action or proceeding which may be filed and shall cooperate fully in the defense, as provided for in Government code section 66474.9.

### **PUBLIC CONTACT**

Public notice requirements are fulfilled by mailing a 10-day public hearing notice to all landowners and residents within 500 feet of the site, by placing a notice on the project site and by posting of the agenda at least 10 days prior to the ARHPB meeting. As of the date of this report no comments have been received in response to the public notice.

### **DISTRIBUTION**

Internal (3)

Mike Sawley, Senior Planner Kelly Murphy, Project Planner

File: AR 21-03

### External (2)

K&M Development, Attn: Allen Knott, 1011 Parkview Avenue, Redding, CA 96001, Email: <a href="mailto:aknott@k2dci.com">aknott@k2dci.com</a>

Nichols, Melburg & Rosetto Architects & Engineers, Attn: Kurt Jorgensen, 555 Main Street, Suite 300, Chico, CA 95928, Email: <a href="mailto:jorgensen@nmrdesign.com">jorgensen@nmrdesign.com</a>


James E. O'Bannon & Susie C. O' Bannon, 1751 Hooker Oak Avenue, Chico, CA


### **ATTACHMENTS**

- A. Location Map
- B. Architect's Narrative

Architectural Review 21-03 (B20 Mixed Use Project) ARHPB Mtg. 04/21/2021 Page 8 of 8

- C. Site Plan
- D. Floor Plan
- E. Color Elevations/Colors and Materials
- F. Color Renderings
- G. Landscaping Plan
  H. Lighting Details

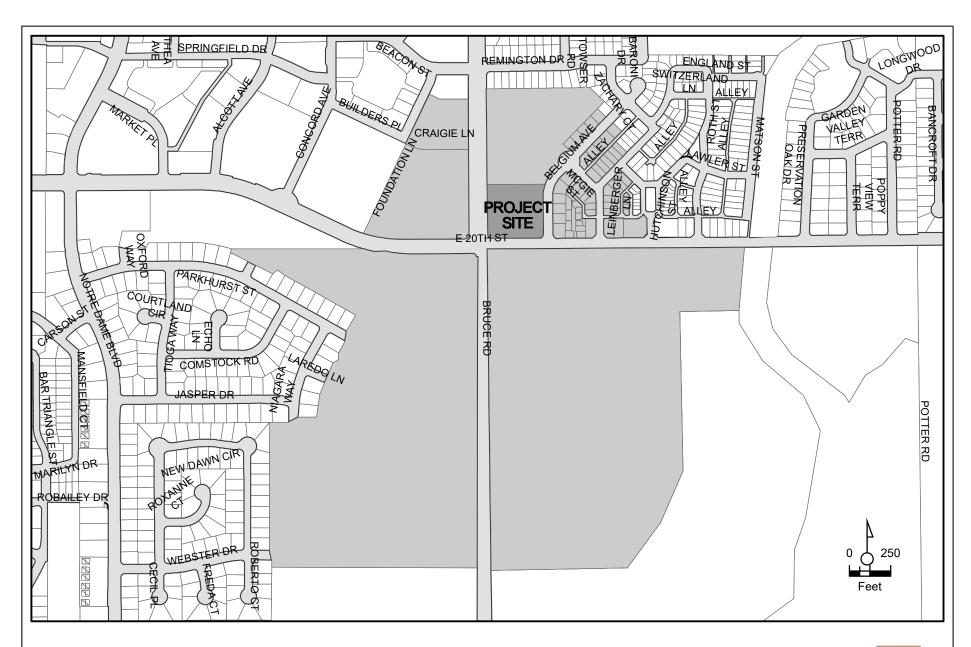

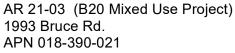





February 4, 2021

Architectural Review and Historic Preservation Board City of Chico Community Development Department 411 Main Street Chico, CA 95928

RE:

**New Mixed-Use Building** 

1993 Bruce Road, NE Corner of Bruce Road and E 20th Street

APN: 018-390-021-000

Architectural Review and Historic Preservation Board Members,

We are pleased to submit this project for your review. It's our intent that the design is consistent with the City of Chico Design Guidelines. The proposed building will contain both residential and commercial spaces in a single, three-story structure at the corner of Bruce Road and E 20<sup>th</sup> Street. The gross area is projected to be just short of 70,000 sf, including attached covered areas.

The development will serve seniors aged 62 and older with income levels between 30%-50% of AMI. The proposal is for a single, L-shaped, three-story building that includes two upper floors of housing with the ground floor facing Bruce Road dedicated to commercial, possibly retail, office or restaurant space. The project is situated on 2.5 acres and will have a total of 60 units of housing, indoor and outdoor community spaces for residents, and about 9,000 sf of commercial space. Unit mix will be 52 one-bedroom units and 8 two-bedroom units.

The community-centered spaces will include a larger activity room with attached kitchen, a smaller meeting room, also serving as quiet space for computers and a library, and laundry room. The senior apartment's office space will include space for two administrative offices and a work area. The manager's leasing office will also be in this area. There will also be space reserved for maintenance and trash/recycling.

Residential parking will be arrayed along the north property line while a commercial parking area complying with zoning requirements will be located in the SE corner. Please note that a majority of the residents will not own any vehicles; this is reflected in the zoning ordinance requirements. Both parking areas will include shade canopies supporting photoelectric solar panels.

### **Exterior Architecture**

The 3-story, wood-framed structure is proposed to have exterior walls composed of stucco, cementitious paneling and siding, and metal siding and panels. The elevations will be enlivened with



balconies, masses with a variety of planes, heights, materials and colors, differentiation between the ground level commercial and upper level residential, variations of window sizes and configurations, and shaded areas, both protruding and inset. The intent is to break up the mass and draw the eye to particular locations of focus.

The building will have a flat roof with both corniced and simple parapets. We're aiming for a simple, modern building made interesting not by decoration but imaginative use of materials and colors, and skillfully detailed, functional elements.

### **Landscape Features**

The building is arranged to provide area for residents to recreate in various capacities, such as playing bocce ball, gardening, or socializing on a patio, with clear demarcation between public and private space. The building will address the major streets, having been shifted away from the smaller scale, single family residences along Belgium. Native and drought tolerant trees and plants will be added to the site.

### **Green Features**

"Green Building" standards will include photovoltaic panels atop carports and on the roof of the building, energy-efficient appliances, high-efficiency plumbing fixtures, EnergyStar Low-E double pane windows, radiant barriers, energy savings light fixtures, tankless water heaters, hardwood laminate floors, zero VOC interior paint, low VOC adhesives and sealants, and ceiling fans.

### **Design Guidelines**

The project will incorporate the following design elements:

- Reinforce pedestrian-friendly paths of travel with walkways inviting the public into the site, including through a covered breezeway. DG 1.1.13
- Locate parking along side or shielded behind a wing of the building or landscaping. DG 1.1.13
- Existing 8' wide sidewalk along Belgium that also accommodates bicycles to be continued along the project's east side, ending at 20<sup>th</sup> Street. DG 1.1.24
- Existing transit stop to be enhanced with bus pullout pocket (and right turn, de-cel lane) on land contributed by the project. DG 1.1.27
- Project to have landscaped courtyard, resident garden, barbecue area and bocce ball court. DG 1.1.32 and 1.1.33
- Courtyard open space in project will be utilized both passively and actively. DG 1.1.42
- Building façades will relate to both residential neighborhoods and more urban, recently erected buildings in Meriam Park with materials, scale, fenestration and detailing. DG 1.2.21
- Parking lot lighting to be 15 ft high cutoff fixtures. Pedestrian pathway lighting to be night sky friendly. DG 1.5.13-15.
- No pole signs to be utilized; all signage to be building mounted or on pedestrian-scaled monument signs. DG 1.6.14-16




- Deciduous shade trees will be utilized on south and west sides. DG 1.7.13
- Roof overhangs and shading devices will be used to optimize passive solar heating and cooling.
   DG 1.7.14
- Parking areas will be located behind the building and screened with landscaping. DG 3.1.24
- Bike parking will be provided near the main building entrance. DG 3.1.34
- A screened trash enclosure will be added, and utilities will be screened/hidden from view.
   DG 3.1.35
- Porches, balconies and windows will face the street to reinforce sense of community. DG 4.1.11
- Massing of building elements, heights and setbacks vary to create interest. DG 4.1.14-15
- Views from residential unit windows, porches and balconies look out on both the street and internal open spaces. DG 4.1.21
- Massing is varied to create non-institutional appearance. DG 4.1.23
- Convenient pedestrian access provided from all residential units to common open space areas and amenities. DG 4.1.41
- Community garden, picnic table/BBQ area, sport court (bocce ball), natural open area with benches are all provided on site. DG 4.1.45
- Building utilizes fenestration to define entries and porches, has thoughtful material changes, and staggered/offset units to provide interest to façade. DG 4.2.11
- Project utilizes a "kit of parts" approach that provides variety while tying together all buildings and facades into a unified whole. DG 4.2.22

We trust that this development will be an enhancement to both the neighborhood and the wider Chico community.

Thank you for your thoughtful consideration,

Kurt A. Jorgensen AIA, Senior Associate Architect

Nichols, Melburg & Rossetto

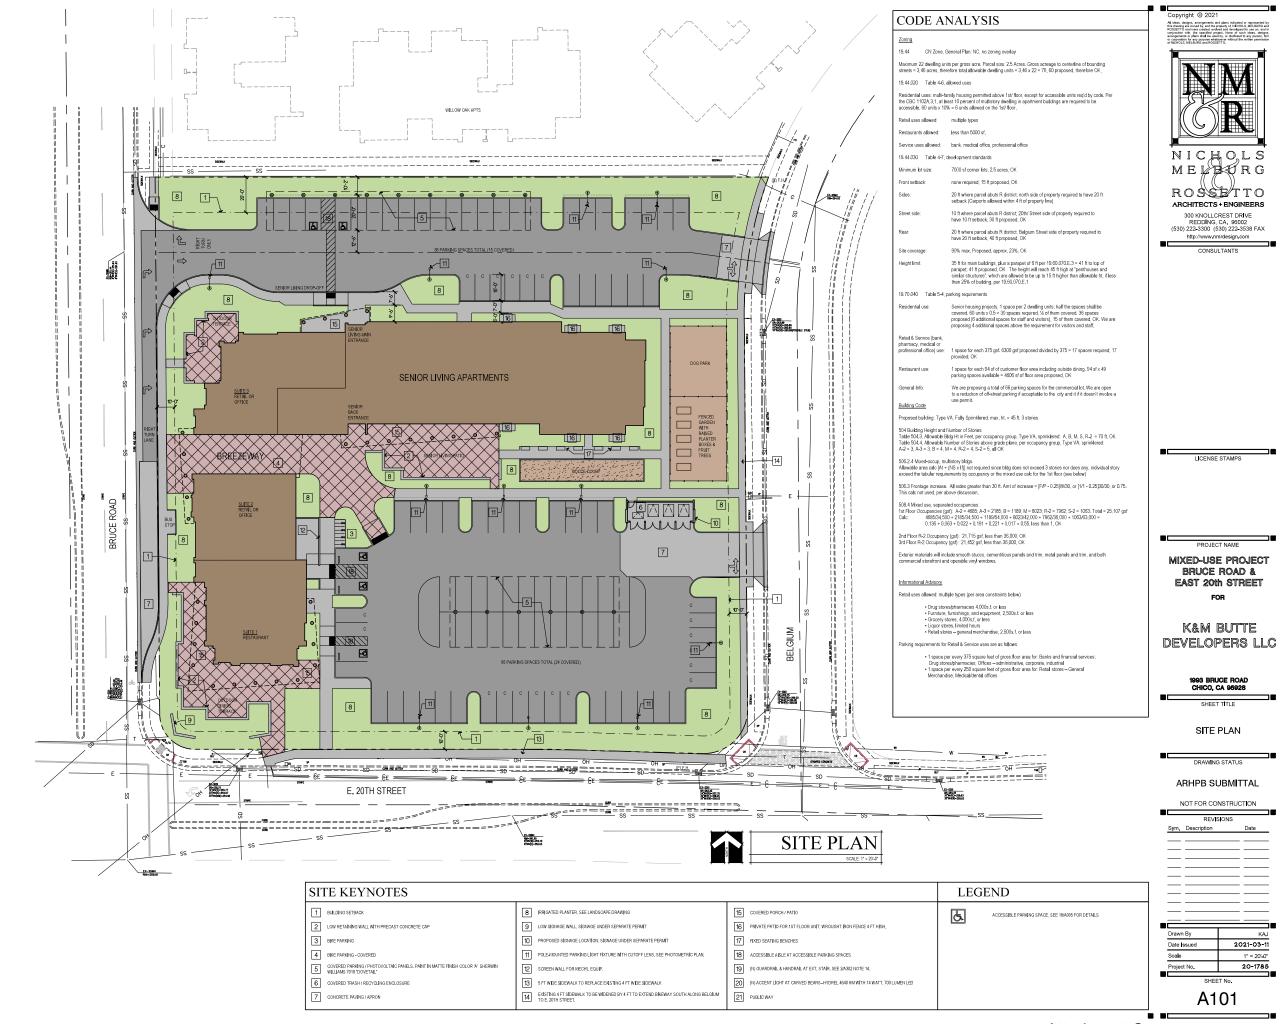





NICHOLS MELITERG ROSSTTO
ARCHITECTS + ENGINEERS
300 KNOLLCREST DRIVE
REDDING, CA. 96002
REDDING, CA. 96002
(530) 222-3338 FAX
http://www.nmrdesign.com

LICENSE STAMPS

MIXED-USE PROJECT BRUCE ROAD & EAST 20th STREET

K & M DEVELOPMENT

SHEET TITLE


1ST FLOOR PLAN

DRAWING STATUS ARHPB SUBM**I**TTAL

NOT FOR CONSTRUCTION

	NOT FOR CO	NSTRUCT	ION
	REVIS	ONS	
Sym,	Description		Date
Drawn	n By		KAJ
Date	ssued	2021	-03-11
Scale		3/	32" = 1'-0"
Projec	t No.	- 1	20-1785

A201 Attachment D • •

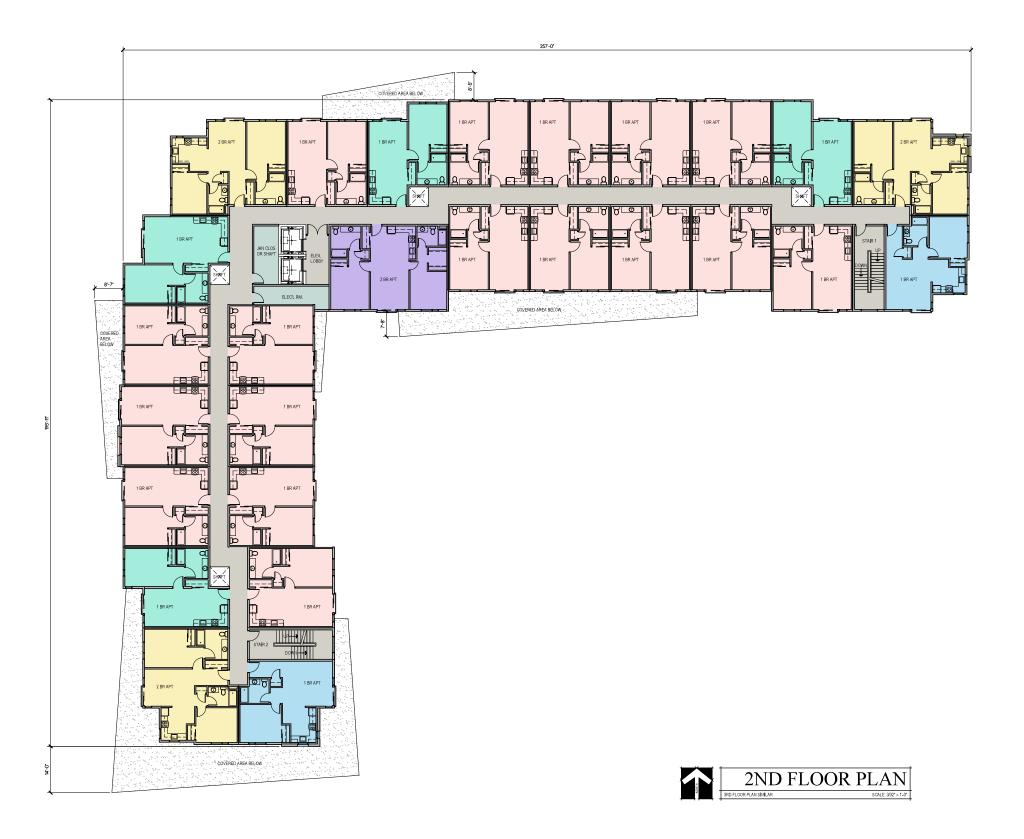



NICHOLS MELBURG ROSSTTO
ARCHITECTS + ENGINEERS
300 KNOLLCREST DRIVE
REDDING, CA. 96002
REDDING, CA. 96002
(530) 222-3338 FAX
http://www.nmrdesign.com

LICENSE STAMPS

MIXED-USE PROJECT BRUCE ROAD & EAST 20th STREET

K & M DEVELOPMENT

2ND FLOOR (THIRD FLOOR SIM)

DRAWING STATUS ARHPB SUBM**I**TTAL

NOT FOR CONSTRUCTION

	1101101100	1101110011011
	REV	SIONS
Sym,	Description	Date
_		
-		
_		
Draw	n By	KAJ
Date	ssued	2021-03-11
Scale	9	3/32" = 1'-0"
Proje	ect No.	20-1785



Copyright © 2010

Allow, from, really an include of recorded by an include of the control of the

LICENSE STAMPS

BRUCE ROAD (WEST) ELEVATION
SCALE 1/8"=140



2 E 20TH ST. (SOUTH) ELEVATION
SCALE: 1/8"=1-10"

KEY NOTES	NOT ALL KEYNOTES ARE USED ON EVERY SHEET	MATERIALS LEGEND	GENERAL NOTES
KEYNOTES ARE TYPIGAL, NOT ALL OCCURANCES ARE CALLED OUT.  1 VINYL WINDOW- FIXED, WHITE 2 VINYL SLIDING GLASS DOOR, WHITE 3 VINYL SLIDING GLASS DOOR, WHITE 4 ALUMINUM STOREFRONT WINDOW ANDIOR DOOR - COLOR 'G' 5 PREFABRICATED, POWDER COATED STEEL RAILING - COLOR 'G' 6 PREFABRICATED, POWDER COATED STEEL GRID CORNICE - COLOR 'G' 7 EXTERNOR PLASTER - COLOR 'B' 8 EXTERNOR PLASTER - COLOR 'B' 9 FIBER CEMENT BOARD PANELING WITH REVEAL JOINTS - COLOR 'G' 1 FLUSH METAL PANEL SIDING 12" WIDTH, VERTICAL INSTALLATION - COLOR'S' 2 SHAPED FOAM TIMI BAND WITH PLASTER TOP COAT; MATCH ADJACENT PLASTER COLOR 'B' 2 SHAPED FOAM TIMI BAND WITH PLASTER TOP COAT; MATCH ADJACENT PLASTER COLOR B' 3 SHAPED FOAM TIMI BAND WITH PLASTER TOP COAT; MATCH ADJACENT PLASTER COLOR B' 4 SHAPED FOAM TIMI BAND WITH PLASTER TOP COAT; MATCH ADJACENT PLASTER COLOR B' 5 PANTES S COLOR'B' 6 PROPOSED SIGNAGE LOCATION (UNDER SEPARATE PERMIT) 7 GALVANIZED STEEL DOOR - PAINT TO MATCH ADJACENT WALL 8 EXTERNOR PLASTER - COLOR 'G' 8 EXTERNOR PLASTER - COLOR 'G' 9 WINDOWS SHADING DEVICE WITH CABLE STAYS - COLOR 'G' 9 WINDOWS SHADING DEVICE WITH CABLE STAYS - COLOR 'G' 9 DOWNSPOUT S SCUPPER, PAINT TO MATCH WALL/MOUNTING SIZE ADJACENT PLASTER COLOR 'G' 9 STEEL DECK ROOF OR GATE, PAINT AS INDICATED 9 STEEL DECK ROOF OR GATE, PAINT AS INDICATED		SEE SEPARATE COLOR BOARD FOR MORE INFO.  COLOR 'A' SMOOTH STUCCO INTEGRAL COLOR, MATCH SHERWIN WILLIAMS 7018 "DOVETAL"  COLOR 'B' SMOOTH STUCCO INTEGRAL COLOR OR PAINT TO MATCH SHERWIN WILLIAMS 7075 "WEB GRAY"  COLOR 'C' SMOOTH STUCCO INTEGRAL COLOR, MATCH SHERWIN WILLIAMS 1001 "SANDS OF TIME"  COLOR 'C' SMOOTH STUCCO INTEGRAL COLOR, MATCH SHERWIN WILLIAMS 6101 "SANDS OF TIME"  COLOR 'C' COLOR 'C' SMOOTH STUCCO INTEGRAL COLOR, MATCH SHERWIN WILLIAMS 9173 "SHITTAKE"  COLOR 'C' CEMENTITIOUS FIBERBOARD AND TRIM, MATCH SHERWIN WILLIAMS 9173 "SHITTAKE"  COLOR 'C' COLOR 'C' CEMENTITIOUS FIBERBOARD AND TRIM, MATCH SHERWIN WILLIAMS 9173 "SHITTAKE"  COLOR 'C' COLOR 'C' CEMENTITIOUS FIBERBOARD AND TRIM, MATCH SHERWIN WILLIAMS 9174 "INKY BLUE"  COLOR 'C' COLOR 'C' COLOR 'C' SHOOTH STUCCO INTEGRAL COLOR, MATCH SHERWIN WILLIAMS 9173 "SHITTAKE"  COLOR 'C' COLOR 'C' SHOOTH STUCCO INTEGRAL COLOR, MATCH SHERWIN WILLIAMS 9173 "SHITTAKE"  COLOR 'C' COLOR 'C' SHOOTH STUCCO INTEGRAL COLOR, MATCH SHERWIN WILLIAMS 9173 "SHITTAKE"  COLOR 'C' COLOR 'C' SHOOTH STUCCO INTEGRAL COLOR, MATCH SHERWIN WILLIAMS 9173 "SHITTAKE"  COLOR 'C' COLOR 'C' SHOOTH STUCCO INTEGRAL COLOR, MATCH SHERWIN WILLIAMS 9173 "SHITTAKE"  COLOR 'C' COLOR 'C' SHOOTH STUCCO INTEGRAL COLOR, MATCH SHERWIN WILLIAMS 9173 "SHITTAKE"  COLOR 'C' COLOR 'C' SHOOTH STUCCO INTEGRAL COLOR MATCH SHERWIN WILLIAMS 9173 "SHITTAKE"  COLOR 'C' COLOR 'C' SHOOTH STUCCO INTEGRAL COLOR MATCH SHERWIN WILLIAMS 9173 "SHITTAKE"  COLOR 'C' COLOR 'C' SHOOTH STUCCO INTEGRAL COLOR MATCH SHERWIN WILLIAMS 9173 "SHITTAKE"  COLOR 'C' COLOR 'C' SHOOTH STUCCO INTEGRAL COLOR MATCH SHERWIN WILLIAMS 9173 "SHITTAKE"  COLOR 'C' SHOOTH STUCCO INTEGRAL COLOR MATCH SHERWIN WILLIAMS 9173 "SHITTAKE"  COLOR 'C' SHOOTH STUCCO INTEGRAL COLOR MATCH SHERWIN WILLIAMS 9173 "SHITTAKE"  COLOR 'C' SHOOTH STUCCO INTEGRAL COLOR MATCH SHOOTH SHOO	1. ALL FLASHING AND ROOF TOP PENETRATIONS TO BE PAINTED TO MATCH ADJACENT ROOF, WALL OR TRIM COLOR AS APPLEABLE, NO UNPAINTED, GALVANZED FLASHING OR VENTS TO BE VISIBLE. 2. ELEV. O''. IS FOR BUILDING REFERENCE ONLY, SEE CML DRAWINGS FOR ACTUAL FLOOR ELEVATIONS. 3. SEE ARCHITECTURAL ELECTRICAL OR LANDSCAPE SITE PLANS FOR SITE ITEMS. 4. SEE FLOOR PLANS FOR WINDOW & DOOR SYMBOLS.

PROJECT NAME

MIXED-USE PROJECT BRUCE ROAD & EAST 20th STREET

FOR

K & M DEVELOPMENT

1993 Bruce Road Chico, CA

SHEET TITLE

EXTERIOR ELEVATIONS

DRAWING STATUS
ARHPB
SUBMITTAL


REVIS	SIONS
Sym. Description	n Date
Drawn By	KAJ
Date Issued	2021-03-11
Scale	1/8" = 1'-0"
Project No.	20-1785
SHEE	T No.





2 INT. ROAD (NORTH) ELEVATION

BELGIUM (EAST) ELEVATION

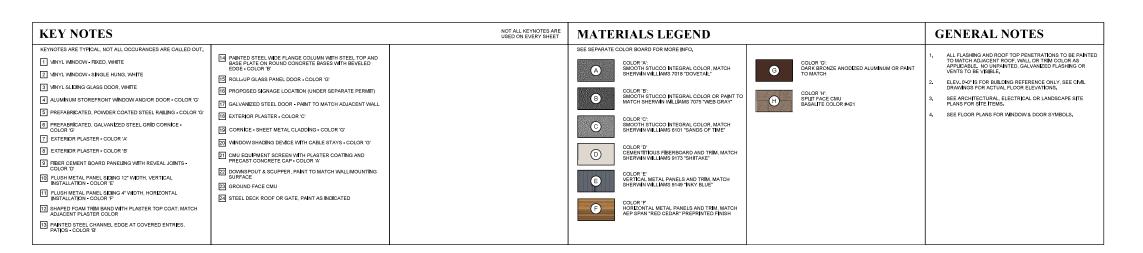

PROJECT NAME

MIXED-USE PROJECT BRUCE ROAD & EAST 20th STREET

LICENSE STAMPS

FOR

K & M DEVELOPMENT

1993 Bruce Road Chico, CA

SHEET TITLE

EXTERIOR ELEVATIONS

DRAWING STATUS
ARHPB
SUBMITTAL

D.FXY	OTONO
	SIONS
Sym. Descriptio	n Date
Drawn By	KAJ
Date Issued	2021-03-11
Scale	1/8" = 1'-0"
Project No.	20-1785
SHE	ET No.






TRASH ENCL. EAST ELEVATION

NICHOLS MELECRG ROSSETTO ARCHITECTS+ENGINEERS 555 MAIN STREET, SUITE 300 CHICO, CA 95928 (530) 891-1710 (530) 891-0138 FAX http://www.nmrdesign.com CONSULTANTS

-24 B 23 H

TRASH ENCL. SOUTH ELEVATION

3 TRASH ENCL. NORTH ELEVATION

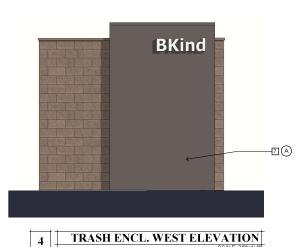

TRASH ENCL. WEST ELEVATION

**KEY NOTES** NOT ALL KEYNOTES ARE USED ON EVERY SHEET MATERIALS LEGEND **GENERAL NOTES** KEYNOTES ARE TYPICAL. NOT ALL OCCURANCES ARE CALLED OUT ALL FLASHING AND ROOF TOP PENETRATIONS TO BE PAINTED TO MATCH ADJACENT ROOF, WALL OR TRIM COLOR AS APPLICABLE. NO UNPAINTED, GALVANIZED FLASHING OR VENTS TO BE VISIBLE. PAINTED STEEL WIDE FLANGE COLUMN WITH STEEL TOP AND BASE PLATE ON ROUND CONCRETE BASES WITH BEVELED EDGE - COLOR 'B' 1 VINYL WINDOW - FIXED, WHITE COLOR 'A': SMOOTH STUCCO INTEGRAL COLOR, MATCH SHERWIN WILLIAMS 7018 "DOVETAIL" COLOR 'G': DARK BRONZE ANODIZED ALUMINUM OR PAINT TO MATCH A G 2 VINYL WINDOW - SINGLE HUNG, WHITE 15 ROLL-UP GLASS PANEL DOOR - COLOR 'G' ELEV. 0'-0" IS FOR BUILDING REFERENCE ONLY, SEE CIVIL DRAWINGS FOR ACTUAL FLOOR ELEVATIONS. 3 VINYL SLIDING GLASS DOOR, WHITE 16 PROPOSED SIGNAGE LOCATION (UNDER SEPARATE PERMIT) COLOR 'B': SMOOTH STUCCO INTEGRAL COLOR OR PAINT TO MATCH SHERWIN WILLIAMS 7075 "WEB GRAY" COLOR 'H': SPLIT FACE CMU BASALITE COLOR #421 В H SEE ARCHITECTURAL, ELECTRICAL OR LANDSCAPE SITE PLANS FOR SITE ITEMS. 17 GALVANIZED STEEL DOOR - PAINT TO MATCH ADJACENT WALL 5 PREFABRICATED, POWDER COATED STEEL RAILING - COLOR 'G' SEE FLOOR PLANS FOR WINDOW & DOOR SYMBOLS. 18 EXTERIOR PLASTER COLOR 'C' COLOR 'C': SMOOTH STUCCO INTEGRAL COLOR, MATCH SHERWIN WILLIAMS 6101 "SANDS OF TIME" 6 PREFABRICATED, GALVANIZED STEEL GRID CORNICE - COLOR 'G' © [9] CORNICE - SHEET METAL CLADDING - COLOR 'G' 7 EXTERIOR PLASTER - COLOR 'A' 20 WINDOW SHADING DEVICE WITH CABLE STAYS - COLOR 'G' COLOR 'D' CEMENTITIOUS FIBERBOARD AND TRIM, MATCH SHERWIN WILLIAMS 9173 "SHIITAKE" 8 EXTERIOR PLASTER - COLOR 'B' D 21 CMU EQUIPMENT SCREEN WITH PLASTER COATING AND PRECAST CONCRETE CAP - COLOR 'A' 9 FIBER CEMENT BOARD PANELING WITH REVEAL JOINTS - COLOR 'D' 22 DOWNSPOUT & SCUPPER, PAINT TO MATCH WALL/MOUNTING SURFACE COLOR 'E' VERTICAL METAL PANELS AND TRIM, MATCH SHERWIN WILLIAMS 9149 "INKY BLUE" 10 FLUSH METAL PANEL SIDING 12" WIDTH, VERTICAL INSTALLATION - COLOR 'E' E 23 GROUND FACE CMU 11 FLUSH METAL PANEL SIDING 4" WIDTH, HORIZONTAL INSTALLATION - COLOR "F" 24 STEEL DECK ROOF OR GATE, PAINT AS INDICATED COLOR 'F' HORIZONTAL METAL PANELS AND TRIM, MATCH AEP SPAN "RED CEDAR" PREPRINTED FINISH 12 SHAPED FOAM TRIM BAND WITH PLASTER TOP COAT; MATCH ADJACENT PLASTER COLOR PAINTED STEEL CHANNEL EDGE AT COVERED ENTRIES, PATIOS - COLOR 'B'

PROJECT NAME

LICENSE STAMPS

MIXED-USE PROJECT BRUCE ROAD & **EAST 20th STREET** 

FOR

K&M DEVELOPMENT

1993 Bruce Road Chico, CA

SHEET TITLE

EXTERIOR ELEVATIONS -TRASH ENCLOSURE

> DRAWING STATUS ARHPB SUBMITTAL

RE	EVISIONS
Sym. Descrip	tion Date
Drawn By	KA
Drawn By Date Issued	KA 2021-03-11
Date Issued	

### Bruce Rd & E 20<sup>th</sup> Street Mixed-Use Building Color Board

**NMR Architects** 

Exterior Stucco Plaster 1—smooth




Proposed Color 'A':



Exterior Stucco Plaster 2—smooth



Proposed Color 'B':

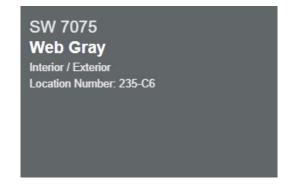

Exposed Steel and Misc. Metals at Canopies




SW 7075
Web Gray
Interior / Exterior
Location Number: 235-C6

# Bruce Rd & E 20<sup>th</sup> Street Mixed-Use Building Color Board continued:


Exterior Stucco Plaster 3—smooth



Cementitious Fiberboard—smooth

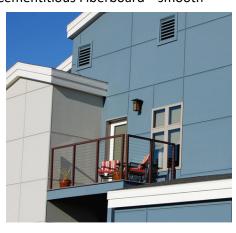

Vertical Metal Siding Prestige 1" Reveal by AEP Span

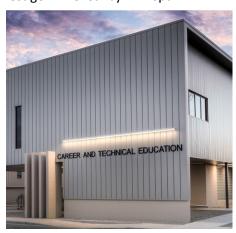

Proposed Color 'C':



Proposed Color 'D':



### Proposed Color 'E':



# Bruce Rd & E 20<sup>th</sup> Street Mixed-Use Building Color Board continued:


Horizontal Metal Siding Perception PC40-12 by AEP Span



Entry Doors and Storefront Window Frames, Louvered Shading Device, Cornice and "Crown"



Ground Face Concrete Masonry Wainscot (Basalite)

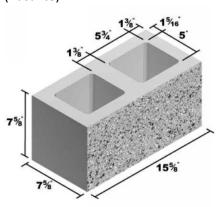

### Proposed Color 'F':



Red Cedar SRI 37 • LRV 12

### Proposed color 'G':



#40 "Dark Bronze" by Kawneer or paint to match

### Proposed color 'H':



#421





NICHOLS MELBURG ARCHITECTS + ENGINEERS
555 MAIN STREET, SUITE 300
CHCO, CA 55928
(500 891-170 (500) 891-070 FAX
http://www.rerrsfsegn.com

LICENSE STAMPS



PROJECT NAME

MIXED-USE PROJECT BRUCE ROAD & EAST 20th STREET

K & M DEVELOPMENT

1993 Bruce Road Chico, CA

SHEET TITLE EXTERIOR VIEWS

DRAWING STATUS ARHPB SUBMITTAL

NOT FOR CONSTRUCTION

REVISIONS		
Sym. Description	Date	
	_	
	_	
	_	
	_	
	_	
	_	

KAJ
2021-03-11
NTS
20-1785





PROJECT NAME

MIXED-USE PROJECT BRUCE ROAD & EAST 20th STREET

NICHOLS MELBURG

ROSSETTO
ARCHITECTS + ENGINEERS
555 MAN STREET, SUITE 300
CHCO, CA. 95929
(530) 891-1710 (530) 891-0738 FAX
http://www.rmrdsegn.com

LICENSE STAMPS

K & M DEVELOPMENT

1993 Bruce Road Chico, CA

SHEET TITLE EXTERIOR VIEWS

DRAWING STATUS ARHPB SUBMITTAL

NOT FOR CONSTRUCTION

REVIS	IONS
Sym. Description	Date
Drawn By	К
Date Issued	2021-03-





NICHOLS MELBURG ROSSETTO
ARCHITECTS + ENGINEERS
555 MAIN STREET, SUITE 300
CHICO, CA 95929
(530) 891-070 (530) 891-078 FAX
http://www.rmrdseign.com

LICENSE STAMPS



PROJECT NAME

MIXED-USE PROJECT BRUCE ROAD & EAST 20th STREET

K & M DEVELOPMENT

1993 Bruce Road Chico, CA

SHEET TITLE EXTERIOR VIEWS

DRAWING STATUS ARHPB SUBMITTAL

NOT FOR CONSTRUCTION

REVISIONS	
Sym. Description	Date
	_
	-
	_
	0.0

KAJ
2021-03-11
NTS
20-1785









NICHOLS MELBURG

ROSSETTO
ARCHITECTS + ENGINEERS
555 MAIN STREET, SUITE 300
CHCO, CA 95928
(530) 891-710 (530) 891-070 FAX
http://www.mrrksgn.com

LICENSE STAMPS

MIXED-USE PROJECT BRUCE ROAD & EAST 20th STREET

K & M DEVELOPMENT

1993 Bruce Road Chico, CA

SHEET TITLE EXTERIOR VIEWS

DRAWING STATUS ARHPB SUBMITTAL

NOT FOR CONSTRUCTION

REVISIONS		
Sym. Description	Date	
	_	
_	_	
	-	

Drawn By	KAJ
Date Issued	2021-03-11
Scale	NTS
Project No.	20-1785

Attachment F







1993 Bruce Road Chico, CA

NICHOLS MELBURG

ROSSETTO ARCHITECTS + ENGINEERS 555 MAIN STREET, SUITE 300 CHICO CA 95928 (530) 891-170 (530) 891-0738 FAX http://www.mrdssign.com

SHEET TITLE

EXTERIOR VIEWS

MIXED-USE PROJECT BRUCE ROAD & EAST 20th STREET

K & M DEVELOPMENT

DRAWING STATUS ARHPB SUBMITTAL

NOT FOR CONSTRUCTION

REVISIONS	3
Sym. Description	Date
_	
	_
_	
_	

Drawn By	KAJ
Date Issued	2021-03-11
Scale	NTS
Project No.	20-1785





LICENSE STAMPS



MIXED-USE PROJECT BRUCE ROAD & EAST 20th STREET

K & M DEVELOPMENT

1993 Bruce Road Chico, CA

SHEET TITLE EXTERIOR VIEWS

DRAWING STATUS ARHPB SUBMITTAL

NOT FOR CONSTRUCTION

REVISI	ONS
Sym. Description	Date
_	
_	
	_
Drawn By	KAJ
Date Teemed	2021-03-11

### PLANT LIST

TREES				
Co-race				
Er + B	QUERCUS LOBATA VALLEY OAK	2	15 GAL	LOW
	QUERCUS ROBUR 'FASTIGIATA' COLUMNAR OAK	5	15 GAL	MEDIUM
	PISTACHE CHINENSIS PISTACHE TREE	11	15 GAL	rom
	ACER X FREEMANII 'AUTUMN BLAZE' AUTUMN BLAZE MAPLE	6	15 GAL	MEDIUM
	ULMUS PARVIFOLIA CHINESE ELM	26	15 GAL	MEDIUM
	PHOENIX DACTYLIFERA DATE PALM	9	15 GAL	LOW
	VARIOUS FRUIT TREES	5	15 GAL	MEDIUM
SHRUBS				
	JUNCUS INFLEXUS BLUE ARROW JUNCUS	160	5 GAL	MEDIUM
	OROPETALUM CHINENSE 'RAZZLEBERRI' MAJESTIC PURPLE RAZZLEBERRI FLOWER	34	5 GAL	MEDIUM
	OSMARINUS OFFICIANLIS 'TUSCAN BLUE' USCAN BLUE ROSEMARY	17	1 GAL	LOW
	SALVIA CLEVELANDII CLEVELAND SAGE	3	5 GAL	row
<b>69</b>	CALAMAGROSTIS X ACUTIFORA "AVALANCHE" AVALANCHE FEATHER REED GRASS	78	1 GAL	LOW
	YIBURNUM TINUS 'SPRING BOUQUET' SPRING BOUQUET YIBURNUM	28	1 GAL	row
	CHONDROPETALUM TECTORUM CAPE RUSH	91	1 GAL	row
Ø	PODOCARPUS MACROPHYLLUS YEW PINE	9	1 GAL	MEDIUM
	FICUS PUMILA MINIMA CREEPING FIG	3	1 GAL	MEDIUM
	BUDDLEJA MARRUBIIFOLIA WOOLLY BUTTERFLY BUSH	163	1 GAL	rom
	IUNIPERUS CHINENSIS 'SKYROCKET' SKYROCKET JUNIPER	9	1 GAL	rom
GROUNDCO'	VER - EQUALLY SPACED			
	CAREX OSHMINENSIS 'EVERGOLD' EVERGOLD SEDGE	2653 SF	1 GAL	LOW
	LIRIOPE MUSCARI 'VARIEGATA' VARIEGATED LILY TURF	2031 SF	1 GAL	MEDIUM
	JUNIPERUS HORIZONTALIS 'BLUE RUG' BLUE RUG JUNIPER	4923 SF	1 GAL	LOW
777	LOROPETALUM CHINENSE 'DARUMA DWA DARUMA DWARF RAZZLEBERRI FRINGE FLO	RF' DWER <sup>230</sup> SF	1 GAL	MEDIUM

### INTERIOR PARKING LOT LANDSCAPE

DESCRIPTION	SQUARE FOOT	PERCENTAGE
TOTAL PARKING LOT AREA LANDSCAPE AREA PROVIDED	34,159 SF 3,095 SF	100 % 9 %
NOTE: 5% MINIMUM REQUIRED	•	

### TREE SPECIES COLOR SCHEMA













### SELECTED SHRUBS AND GROUNDCOVER









**NOTES** 

### 1. SOILS NOTE

ALL PARKING LOT ISLANDS AND TREE PLANTING PITS WILL BE SCARIFIED TO A MINIMUM DEPTH OF 30" BY THE FULL LENGTH AND WIDTH OF THE PARKING LOT ISLAND OR 8" DIAMETER, CENTERED ON TREE PLANTING, SO AS TO DE-COMPACT SOILS, CONTRACTOR SHALL SOLICIT AS SOILS REPORT FROM AN ANALYTICAL LABORATORY AND AMENDS SOILS AS RECOMMENDED BY THE ANALYTICAL LABORATORY.

ALL LANDSCAPED AREAS SHALL BE IRRIGATED BY MEANS OF AN AUTOMATICALLY CONTROLLED, LOW VOLUME DRIP OR BUBBLER IRRIGATION SYSTEM. OVERHEAD IRRICATION WILL NOT OCCUR WITHIN 24" OF ANY NON-PERMEIABLE SURFACE. ALL SYSTEMS WILL FOLLOW MWELO (MODEL WATER EFFICIENT LANDSCAPE ORDINANCE) STANDARDS. ALL TREES WILL BE ON SEPARATE HYDROZONES.


#### 3. SITE AMENITIES

SEE ATTACHED SITE PLAN SHEET FOR ADDITIONAL SITE AMENITIES.

INORGANIC MULCH AND LANDSCAPE FABRIC NOT PERMITTED IN PUBLIC RIGHT-OF-WAY.

### SHADE SYMBOLS

PROPOSED TREE - 25' DIAMETER	QTY.	AREA	TOTAL
H HALF OF CANOPY AREA COUNTED	5	771 SF	3,855 SF
PROPOSED TREE - 40' DIAMETER			
Q QUARTER OF CANOPY AREA COUNTED	1	314 SF	314 SF
H HALF OF CANOPY AREA COUNTED	1	628 SF	628 SF
TQ THREE QUARTERS OF CANOPY AREA COUNTED	5	942 SF	4,710 SF
PROPOSED TREE - 65' DIAMETER			
H HALF OF CANOPY AREA COUNTED	2	528 SF	1,056 SF
TOTAL TREE SHADE PROVIDED			10,563 SF

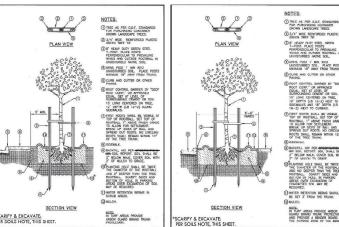

BACK OF WALK PLANTING LS-1

PARKWAY STRIP PLANTING LS-1
SHADE CALCULATIONS


DESCRIPTION (ALLEY NOT INCLUDED)	SQUARE FOOT	PERCENTAGE
TOTAL PARKING LOT AREA (NEW PARKING ONLY) SHADE AREA PROVIDED (TREES, COVERED PARKING)	34,159 SF 17,107 SF	100.0% 50.0%
NOTE: 50% MINIMUM REQUIRED		

### SITE SUMMARY

E. 20TH STREET

SENIOR LIVING APARTMENTS

20 20 20 20 20 20 20 20 20 20 20 20 20 2		
ESCRIPTION - INCLUDES EXISTING LANDSCAPE	SQUARE FOOT	PERCENTAC
TOTAL SITE AREA	108,916 SF	100%
TOTAL BUILDING FOOTPRINT	20,469 SF	19%
TOTAL PARKING LOT AREA	34,159 SF	31%
TOTAL LANDSCAPE AREA	27,562 SF	25%
TOTAL SIDEWALKS, CURBS & MISC	26,726 SF	25%

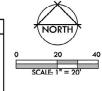

## **B20 MIXED USE**



PRELIMINARY LANDSCAPE MASTER PLAN


PREPARED FOR: **K& M DEVELOPMENT** CHICO, CA










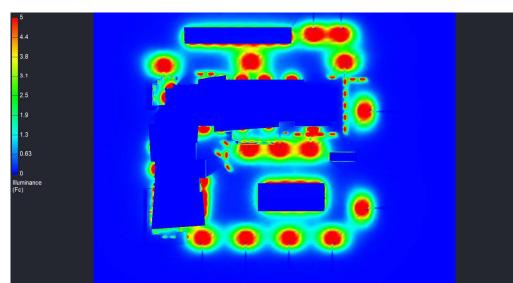

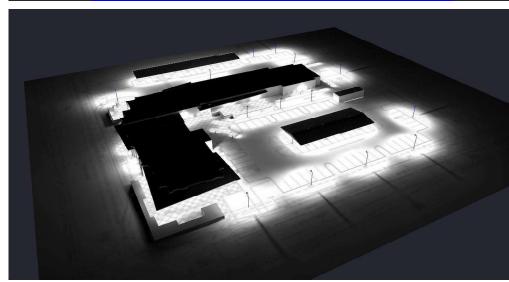





TYPE B



TYPE C



TYPE E

Parking Grid 2

TYPE D

TYPE F

Luminaire Schedule							
Symbol	Label	Qty	LLF	[MANUFAC]	Description	Lum. Watts	Total Watts
+	Α	17	0.900	NICOR, Inc.	OUC1045MV40WH	45.81	778.77
-	В	14	0.900	NICOR Inc.	OAL-2-060-MV-50-8-BZ3	58.04	812.56
•	С	20	0.927	Selux Corporation	OBH-R-7-10-U-XX-XX-39-XX	10	200
•	D	9	0.900	NICOR, Inc.	OSA1030MV50BZ	28.75	258.75
$\odot$	E	18	0.900	NICOR INC	CLR6-1015-UNV-40K-WH	16.75	301.5
-	F	22	1.000	NICOR Inc.	STW-1-120-3K-H	4.29471	94.48363

Calculation Summary							
Label	CalcType	Units	Avg	Max	Min	Avg/Min	Max/Min
DROP-OFF AREA	Illuminance	Fc	2.82	5.1	0.4	7.05	12.75
Parking_Grid_1	Illuminance	Fc	3.28	18.1	0.2	16.40	90.50
Parking_Grid_2	Illuminance	Fc	2.84	16.2	0.1	28.40	162.00
Pedestrian Walkways	Illuminance	Fc	2.77	13.8	0.0	N.A.	N.A.
Trash Enclosure_Bottom	Illuminance	Fc	15.73	24.2	7.5	2.10	3.23

### Note on this Design:


This report makes no representations in regard to Lighting Design or Specification, rather it attempts to accurately reflect the photometric results of a design, as approved by others.

### Note on these Photometric Calculations:

This analysis is a mathematical model and can be only as accurate as is permitted by the third-party software and the IES standards used. All digital CAD data appear to be accurate, however, this apparent accuracy is an artifact of the techniques used to generate it and is in no way intended to imply accuracy in the real world.

There are many factors that will impact the actual performance of Lighting in the constructed space, including: the accuracy of the original source (.ies) files supplied by the manufacturer, input voltage ballast variances, actual finish values in the constructed environment, manufacturing variations in both the source (lamp) and the luminaire, final luminaire placement, obstructions, and installation quality. Further, field measurement itself is subject to errors arising from measuring methods and/or technology selected, and the knowledge/ability of the measuring party. While the creator of this lighting study makes every effort to ensure accuracy, they cannot be held liable for any errors. The recipient of this lighting study understands and accepts that the likelihood of scaling error increases when no .DWG file or other properly-dimensioned drawing is provided to the designer.

NB: Reflective Values have a significant effect on light levels, the end-user of the document should confirm these values before accepting the results of any photometric report. The managing contractor/architect/engineer is responsible for ensuring compliance to all relevant lighting ordinance(s) and energy codes required on this project.

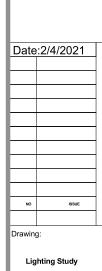

Design By: N.K.

rawing Number:



Bruce Rd. & E 20th St. - Site Lighting

Date	:2/4/2021	
NO	ISSUE	
Drawing	g:	
Lig	hting Study	
De	sign By: N.K.	
Drawing 2	g Number:	
		- 1

Attachment H