

Meeting Date 12/19/18

DATE: November 26, 2018

File: PDP 18-01

TO: Architectural Review and Historic Preservation Board

FROM: Shannon Costa, Assistant Planner (879-6807, shannon.costa@chicoca.gov)

RE: Eaton Ranch Planned Development Permit

Located on the South Side of E. Eaton Rd between Floral Avenue and Ceanothus

Avenue, APNs: 016-200-017 and 016-340-034

#### **SUMMARY**

The applicant requests a Board recommendation for approval of a Planned Development Permit to construct a 257-unit apartment project on a vacant site consisting of two parcels totaling 15 acres. A Planned Development Permit is necessary to satisfy condition of approval of the Mountain Vista Subdivision and Planned Development Permit (S/PDP 01-12) and the Sycamore Glen Subdivision and Planned Development Permit (S/PDP 00-11). The intended purpose of the Planned Development Permit is to ensure that a minimum number of multifamily residential housing units are constructed to meet required densities of the General Plan. No modifications of development standards are proposed as part of the Planned Development Permit.

With a Board recommendation, the proposal must go to the Planning Commission for final consideration of the permit, including final architectural design approval.

#### RECOMMENDATION

Staff recommends that the Architectural Review and Historic Preservation Board adopt the required findings contained in the agenda report and recommend approval of the project, subject to conditions.

#### **Proposed Motion:**

I move that the Architectural Review and Historic Preservation Board adopt the required findings contained in the agenda report and recommend approval of Eaton Ranch Planned Development Permit (PDP 18-01), subject to the staff recommended conditions contained therein.

#### **BACKGROUND**

The applicant proposes to construct 19 apartment buildings with a total of 257 units, developed in two phases. The overall site is 15-acres in size, bounded by E. Eaton Road to the north, Floral Avenue to the west, Ceanothus Avenue to the east and a 40-foot-wide Pacific Gas and Electric (PG&E) easement to the south (see **Attachment A**, Location Map and **Attachment B**, Overall Site Plan). The site is zoned R3-AOC-PD (Medium-High Density Residential with Airport Overflight Zone C and Planned Development Permit overlay) and designated Medium High Density Residential in the General Plan Land Use Diagram. Surrounding land uses includes single family homes and a vacant parcel to the north, zoned for commercial use.

PDP 18-01 (Eaton Ranch Ph I and II) ARHPB Mtg. 12/19/2018 Page 2 of 7

The project site is identified for multi-family residential development by the Mountain Vista Subdivision (S/PDP 01-12) and Sycamore Glen Subdivision (S/PDP 00-11) project approvals. The intended purpose of the Planned Development Permit is to ensure that a minimum number of multi-family residential housing units are constructed to meet required densities of the General Plan. These approvals stipulate that the total number of units required for Phase I (Lot 215, Mountain Vista Subdivision) is 114 units and the total of number of units required for Phase II (Lot 199, Sycamore Glen Subdivision) is 143 units (257 units total). The proposed project is consistent with the densities adopted for the Mountain Vista/Sycamore Glen projects.

### Phase I and Phase II Architecture

The overall project design for Phase I and Phase II features a bungalow-agrarian style architecture, consistent with the surrounding single-family residential development (see **Attachment C**, Architect Description). Apartment buildings would be a combination of four building types; Building Type A would contain 12 units and 14 private ground-floor garages, Building Type B would contain 16 units, Building Type C would contain 11 units, and Building Type D would contain 11 units. Each building, including the amenities building, would feature identical architectural styling with minor distinguishing details.

Apartment buildings would be two-stories in height with an assortment of exterior finishes and colors (see **Attachment D**, Apartment Building Elevations). The main body of each building would be fiber cement in variations of beige and brown with accent colors in green and brown. Building masses would be differentiated by varied gable roof planes and heights. Amenities buildings, such as the cabana building and leasing office, would be single story and feature architectural styling consistent with the apartment buildings (see **Attachment E**, Amenities Elevations).

A variety of textures and materials would be used on the exterior of the buildings, including wood-grain lap siding, wood-grain vertical siding, stucco and wood-grain cement fiber panels. Window glazing would be white vinyl and outdoor private patio areas would be enclosed by vertical wood-grain panels in dark brown (see **Attachment F**, Colors and Materials). As mentioned, Building Type A would feature first-floor private garages featuring metal garage doors in dark brown. Steel-post carport structures would be located through the parking lot featuring a metal posts and roof. Trash enclosures located throughout the site would be CMU brick with metal trellis covers. These structures would be painted to match the color scheme of the apartments (see **Attachment G**, Carport and Trash Enclosure Elevations). Ground-mounted HVAC units and building-mounted gas meters are screened from public view by a low, metal-mesh fence panel and extensive landscape treatment.

#### Phase I and Phase II Landscaping

The landscape plan calls for a variety of species, predominately with low to moderate water demands (see **Attachment H**, Phase I and Phase II Landscape Plan). Ample landscaping is provided throughout both parcels, with close attention paid to areas surrounding amenities. The base of each building would feature extensive ground cover, including star jasmine and creeping germander. The E. Eaton Road frontage would include rows of elm trees with various shrubs and groundcover throughout the parkway. Site lighting is provided by box fixtures mounted 14-feet in height, bollards located throughout pedestrian walkways, and lights mounted beneath carport. All exterior lighting would be low-intensity and energy efficient (see **Attachment I**, Light Fixtures).

PDP 18-01 (Eaton Ranch Ph I and II) ARHPB Mtg. 12/19/2018 Page 3 of 7

The site plan demonstrates the layout of the proposed project, including the location and orientation of the buildings, pool and other tenant amenities, landscaping, trash enclosure, carports and site lighting. The specific site plan aspects of each phase will be discussed separately below.

#### Phase I Site Plan

Phase I is located on the south side of E. Eaton Road, between Floral Avenue and Mariposa Avenue (see **Attachment J**, Phase I Site Plan). The site is accessed by two entry points; primary access would be from a four-lane entry from E. Eaton Road and secondary access would be provided by a single-lane access point on Mariposa Avenue. Each access point would be secured by an electric gate that would remain open during daytime hours and would close in evening/nighttime hours. Tenants would be able to access the site through a keypad entry, or with a remote control.

The site would include a total of 10 buildings as well as resident amenities, including a pool, clubhouse and cabana, fitness room and leasing office. The apartment buildings are oriented such that four buildings would front E. Eaton Road, while buildings closer to the rear of the site would be situated perpendicularly, reducing building interface with the adjacent residential neighbors.

Resident amenities would be situated central to the site surrounding an outdoor pool and patio area. A large amenities building would be located northeasterly of the outdoor pool area and would contain a leasing/staff office, yoga studio, business center, clubhouse, game room and mail room. A smaller cabana building would be situated west of the pool and would contain a shaded lounging area. A pet spa, bike repair area and pool equipment storage building would be located adjacent to the cabana building. The entire amenities area would be enclosed by a six-foot-tall horizontal wood fence and extensive landscaping.

A total of 265 vehicle parking spaces are provided on the Phase I site. Parking is provided by; 42 private garage spaces located within the first-floor of Buildings 4, 5, and 9; 109 spaces covered by metal carport structures, or; 114 open parking spaces. Parking lot shade, which is estimated to reach 52-percent at full tree maturity, is provided by scarlet oak and cork oak trees.

#### Phase II Site Plan

Phase II is located on the south side of E. Eaton Road, between Mariposa Avenue and Ceanothus Avenue, adjacent to the PG&E substation (see **Attachment K**, Phase II Site Plan). The site is accessed by two entry points; primary access would be taken from a four-lane gated entry from E. Eaton Road and secondary access would be provided by a single-lane entry on Ceanothus Avenue. Each access point would be secured by an electric gate that would remain open during daytime hours and would close in evening/nighttime hours. Tenants would be able to access the site through a keypad entry, or with a remote control.

The site would include a total of nine apartment buildings as well as resident amenities, including a pool, clubhouse and fitness room. The apartment buildings are oriented such that three buildings would front E. Eaton Road, while buildings closer to the rear of the site would be situated perpendicularly, reducing building interface with the adjacent residential neighbors.

PDP 18-01 (Eaton Ranch Ph I and II) ARHPB Mtg. 12/19/2018 Page 4 of 7

A total of 217 vehicle parking spaces are provide on the Phase II site. Parking is provided by; 42 private garage spaces located within the first-floor of Buildings 2, 8, and 9; 83 carport parking spaces, or; 90 open parking spaces. Parking areas associated with the project are located towards the interior and sides of the site, screened from view by buildings and landscape features.

#### **DISCUSSION**

The proposed project would establish a medium-high density residential use on a site identified for multi-family residential use by the City of Chico zoning map and General Plan Land Use Designation. The proposal is compatible with the surrounding single-family homes developed as part of the Mountain Vista/Sycamore Glen developments, matching architectural features, style and color themes.

The project is consistent with General Plan policies that encourage compatible infill development (LU-4.2 and LU-4.3), context-sensitive design (CD-5.2 and CD-5.3) and providing an adequate supply of rental housing to meet a wide range of renters and future needs throughout the city (H.3, H.3.2, and H.3.4). The placement of the buildings on the site is consistent with policies that encourage orientating multi-family housing developments and front entries towards to the street (DG 4.1.13 and 4.1.35). The parking area is located to the rear of the buildings, providing vehicle visibility to residents while reducing views of automobiles from the public street (DGs 1.1.14, 4.1.52, and 4.1.53). The project includes a shared recreational area consistent with Design Guidelines (DGs) that call for incorporating common space into the project design (DGs 1.1.42, 4.1.42, 4.1.43, and 4.1.45).

#### Neighborhood Meeting

On October 22, 2018, a neighborhood meeting was held at the project site. The meeting was attended by the project applicant, engineer, contractor, landscape architect, City staff and approximately 27 neighbors. The project consultant presented the project and answered questions, mostly about the height of the structures, if the units would be market rate or designated for low income, and what the rear fencing/landscaping design would be. Project representatives answered questions and displayed illustrations depicting the proposed two-story buildings, the approximately 35-foot rear year separation with the residential neighbors and clarified that the units would be market-rate (see **Attachment L**, Neighborhood Meeting Minutes).

#### REQUIRED FINDINGS FOR APPROVAL

#### <u>Environmental</u>

The project falls within the scope of the Environmental Impact Report (EIR) for the Mountain Vista/Sycamore Glen Vesting Tentative Subdivision/Planned Development Permit (S/PDP 01-012 and S/PDP 00-11), which was certified by the City Council on July 17, 2017. Pursuant to Section 15162 of the California Environmental Quality Act, no subsequent environmental review is necessary, as there have been no substantial changes to the project which would require revisions of the EIR, no substantial changes have occurred with respect to the circumstances under which the project is being undertaken which would require major revisions of the EIR, and no new information has become available which was not known and could not have been known at the time the EIR was completed.

PDP 18-01 (Eaton Ranch Ph I and II) ARHPB Mtg. 12/19/2018 Page 5 of 7

### **Architectural Review**

According to the Chico Municipal Code Section 19.18.060, the Architectural Review and Historic Preservation Board shall determine whether or not a project adequately meets adopted City standards and design guidelines, based upon the following findings

1. The proposed development is consistent with the General Plan, any applicable specific plan, and any applicable neighborhood or area plans.

The project is consistent with General Plan policies that encourage compatible infill development (LU-4.2 and LU-4.3), and context-sensitive design (CD-5.2 and CD-5.3) and providing an adequate supply of rental housing to meet a wide range of renters and future needs throughout the city (H.3, H.3.2, and H.3.4). The site is not located within the bounds of a Neighborhood Plan or area plan.

2. The proposed development, including the character, scale, and quality of design are consistent with the purpose/intent of this chapter and any adopted design guidelines.

The placement of the buildings on the site is consistent with policies that encourage orienting multi-family housing developments and front entries towards to the street (DG 4.1.13 and 4.1.35). The parking area is located to the rear of the buildings, providing vehicle visibility to residents while reducing views of automobiles from the public street (DGs 1.1.14, 4.1.52, and 4.1.53). The project includes a shared recreational area consistent with Design Guidelines (DGs) that call for incorporating common space into the project design (DGs 1.1.42, 4.1.43, and 4.1.45).

3. The architectural design of structures, including all elevations, materials and colors are visually compatible with surrounding development. Design elements, including screening of equipment, exterior lighting, signs, and awnings, have been incorporated into the project to further ensure its compatibility with the character and uses of adjacent development.

The proposal is compatible with the surrounding single-family homes developed as part of the Mountain Vista/Sycamore Glen developments, matching architectural features, style and color themes. Ground-mounted utilities would be hidden from view, and the trash area would be appropriately screened (DG 3.1.35). The parking lot features appropriate lighting that would not create unnecessary glare impacts on residents or neighboring properties (DG 4.1.44).

4. The location and configuration of structures are compatible with their sites and with surrounding sites and structures, and do not unnecessarily block views from other structures or dominate their surroundings.

The design, materials and color palette of the proposed buildings are visually compatible with the surrounding neighborhood and would not unnecessarily block views from other structures. The proposal would introduce two-story buildings in an area predominantly developed with single-story homes, however, placement of the buildings towards the front of the site would reduce building interface with the adjacent neighbors. Exterior equipment will be properly screened in the rear yards of each unit by fences or painted to match the structures. Parking lot lighting is proposed at a pedestrian scale and will not result in any unnecessary source of glare or contribution to the night sky pollution.

5. The general landscape design, including the color, location, size, texture, type, and coverage of plant materials, and provisions for irrigation and maintenance, and protection of landscape elements, have been considered to ensure visual relief, to complement structures, and to provide an attractive environment.

The proposed landscaping and additional outdoor amenities will create and attractive outdoor environment. Ample landscaping is provided throughout both sites, with close attention paid to areas surrounding resident amenities and the E. Eaton Road frontage. Tree and plant species have been thoughtfully and appropriately selected for their locations and the variety of plant types will provide color, texture and coverage to the overall project.

#### RECOMMENDED CONDITIONS OF APPROVAL

- 1. All approved building plans and permits shall note on the cover sheet that the project shall comply with PDP 18-01 (Channel Eaton Road).
- All wall-mounted utilities and roof or wall penetrations, including vent stacks, utility boxes, exhaust vents, gas meters and similar equipment, shall be screened by appropriate materials and colors. Adequate screening shall be verified by Planning staff prior to issuance of a certificate of occupancy.
- 3. All new electric, telephone, and other wiring conduits for utilities shall be placed underground in compliance with CMC 19.60.120.

#### **PUBLIC CONTACT**

A 10-day public hearing notice was mailed to all landowners and residents within 500 feet of the site. A legal notice was also placed in the *Chico Enterprise Record*. As of the date of this report, no correspondence has been received in response to the public notice.

#### **DISTRIBUTION:**

AR Distribution Mike Sawley, Senior Planner Shannon Costa, Assistant Planner

File: PDP 18-01

#### External

Channel Properties, c/o Mark Funseth, 1850 Soscol Avenue, suite 207, Napa, Ca 94559 (mfunseth@channelprop.com)

FAE Holdings, LLC, 100 W. Cutting Blvd, Richmond, CA 94804


Rural Consulting Associates, attn.: Jim Mann, 140 Yellowstone Drive, Suite 160, Chico, CA 95973 (jimatrural@aol.com)

#### **ATTACHMENTS**:

- A. Location Map
- B. Overall Site Plan
- C. Architect Description
- D. Apartment Building Elevations
- E. Amenities Building Elevations
- F. Colors and Materials

PDP 18-01 (Eaton Ranch Ph I and II) ARHPB Mtg. 12/19/2018 Page 7 of 7


- G. Carport and Trash Enclosure ElevationsH. Phase I and Phase II Landscape Plans
- I. Light Fixtures
- J. Phase I Site Plan
- K. Phase II Site Plan
- L. Neighborhood Meeting Minutes

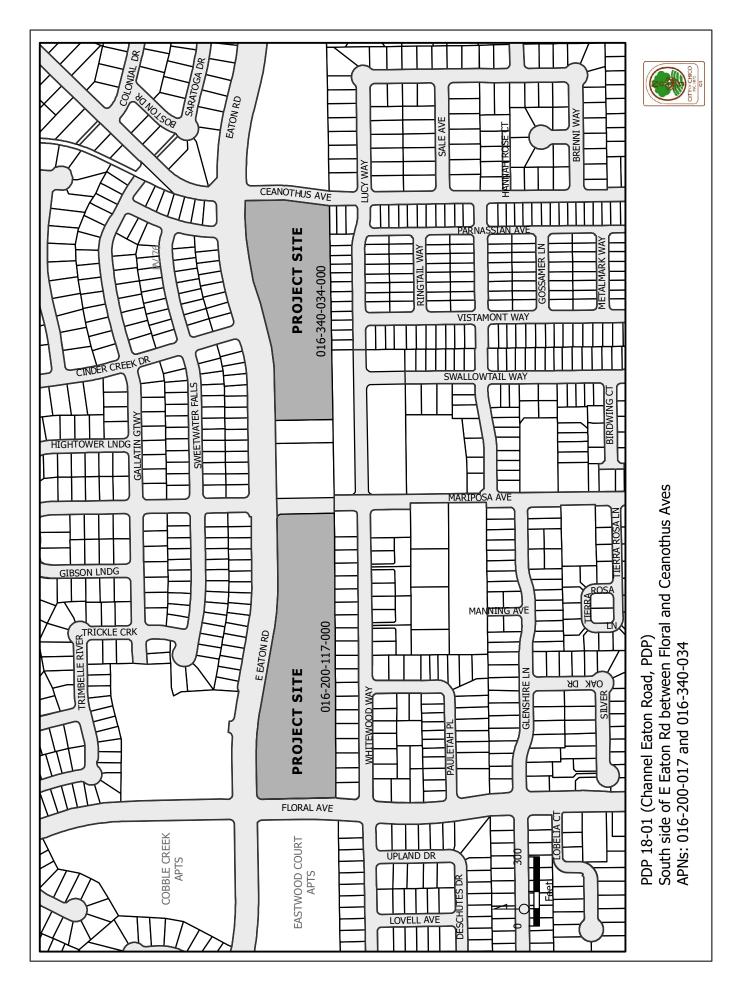


ĐU	SFACE/DU	PAION KANGILI	FAILM KANCILI	NIN
I.BR	1.25	49	43	91
2 BR	1.75	147	109	256
3 BR	2.0	40	36	76
SUBTOTAL		236	187	423
GUEST	0.2	29	23	52
DIAL		264	210	475
REQ. ACCESSI	BLE STALLS	7	5	12
INCLINIOIA	C)			

PARRIDIS ESCIMIDED				
PARKING TIPE	EATON RANCHI	EATON RANCH II	TOTAL	
GARAGES	41	41	82	
2% ACCESSIBLE GARAGE	1	1	2	
CARPORT	106	83	189	
2% ACCESS/BLE CARPORT	3	2	5	
OPEN	111	87	198	
2% ACCESSIBLE OPEN	3	3	6	
TOTAL	265	217	482	



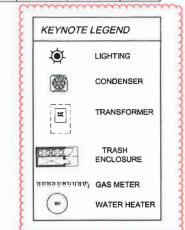

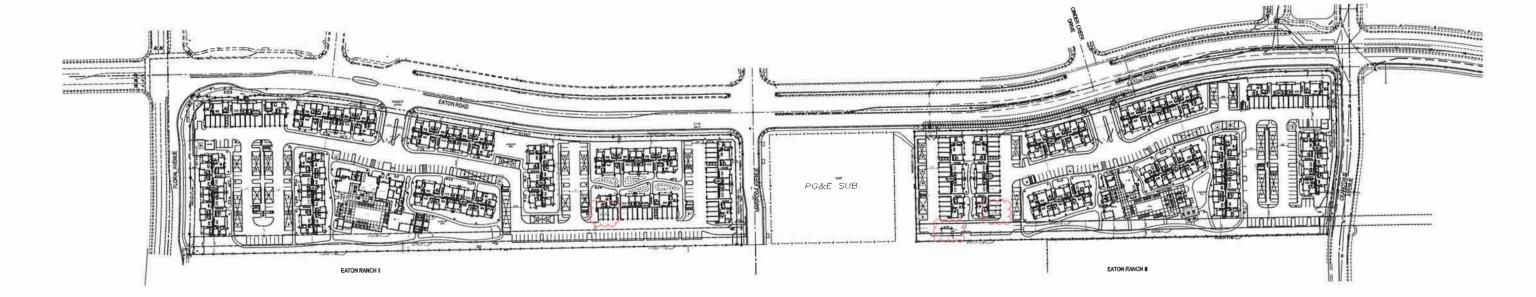



**OVERALL SITE PLAN** 

A1.2

**EATON RANCH** 

# **Rural Consulting Associates**

140 Yellowstone Drive, Suite 160 Chico, CA 95973

Land Development • Entitlements Project Management

(530) 899-9849 FAX (530) 891-3690

September 10, 2018

CITY OF CHICO PLANNING DEPARTMENT P.O. Box 3420 Chico, CA 95927

Re: Eaton Ranch I and II Apartment Project

APN 016-200-117 & 016-340-034

It is a pleasure to bring an apartment project forward that has been carefully planned over the last several months. The owner's first brought Eaton Village Unit I & II to the Chico Architectural Review Board back in 2008. The same team is now bringing the proposed Eaton Ranch I & II Apartment Project to the Chico Architectural and Historic Preservation Review Board.

Eaton Ranch is a multi-family community consisting of 257 total residential units in multiple buildings on 2 parcels. The design intent is to provide a unique residential project that fits within the context of the neighborhood with its predominantly 2 story massing and bungalow-agrarian style architecture. DG 1.2.11, DG 1.2.12, DG 1.2.13, DG 4.2.11, DG 4.2.22

Eaton Ranch I & II is site planned the same way, in that residential buildings interface on Eaton Road, and the clubhouse for each parcel is framed by two residential buildings situated on either side of the entry drive. DG 4.1.11, DG 4.1.13, DG 4.1.45

Ground floor patios with low roof elements are placed at various points along Eaton Road to provide pedestrian scale and "eyes on the street' as well as engagement with the public realm. DG 4.1.11, DG 4.1.13, 4.1.24, DG 4.2.22

Varied roof forms, alternative color schemes, plane undulation and attractive mix of materials, textures, and 4 sided architecture promotes visual interest and break up the overall massing of each building. DG 4.1.15, DG 4.1.23, DG 4.2.11, DG 4.2.13, DG 4.2.22, DG 4.2.31

Amenities of resort style living, and sense of community is enforced throughout the project with its landscaping, system of walking paths throughout the site, including along the easement. DG 4.1.11, DG 4.1.45, DG 4.1.52, DG 4.2.32

Included with the project will be outdoor activity nodes such as pools, spas, courtyards, formal and casual vista points, and indoor amenities such as clubhouses and fitness centers. DG 4.1.45

Appropriate lighting DG 4.1.44 for common open space areas, including walkways, carports, and buildings will enhance a safe environment, and will not create unnecessary glare impacting residents, or adjacent neighboring properties.

Utility services will be screened from public view DG 3.1.35. Trash enclosures will be contained within masonry buffered areas. Wall mounted utility equipment, including electrical panels, gas meters, conduits, plumbing or downspouts, with be within closets, integrated within the building structure or by screening (landscape or mesh panels) and buffered. DG 3.2.28

Sincerely

Jim Mann, Consultant

Eaton Ranch I & II Apartments



### PLANNING STREET DEPARTMEN

411 Maintife at Engineer regimes in his PO 848 3400 Chico, CA 05927

nativities of a second

April 23, 2012

Pete Giampaoli **Epick Homes** 901 Bruce Road, Suite 280 Chico, California 95928

Re:

Sycamore Glen and Mountain Vista Vesting Tentative Subdivision Map/Planned

Development Permit - Minor Modification of Planned Development Permit

Dear Mr. Giampaoli:

The Planning Services Director has approved your request to shift 10 multi-family residential units from the Sycamore Glen map to the Mountain Vista map in order to make the multi-family residential density of both developments consistent (see attached memo approving the request).

Should you have any questions, please contact me at (530) 879-6807 or by email at bsummerv@ci.chico.ca.us

Bob Summerville, AICP

Senior Planner

Attachments:

Memo, Planning Services Director, 4/20/12

cc:

Mike Byrd c/o Rolls, Anderson, Rolls, 115 Yellowstone Drive, Chico, CA 95973

Matt Johnson, Senior Development Engineer

Files: S/PDP 00-11 and S/PDP 01-12

Nelson George, Building Official (subdivision files)

X:\Staff\*Folders\BSummerville\MY.DOC\SUB\MV-SG\00-11 Sycamore Glen\min mod appivl ltr 4-23-12-wpd





# CITY OF CHICO MEMORANDUM

TO:

Project File

DATE:

April 20, 2012

FROM:

Bob Summerville, AICP, Senior Planner

FILE:

S/PDP 00-11 and S/PDP 01-12

RE:

Sycamore Glen and Mountain Vista Vesting Tentative Subdivision Map/Planned

Development Permit - Minor Modification of Planned Development Permit

The City Council approved Sycamore Glen (S/PDP 00-11) and Mountain Vista (S/PDP 01-12) Vesting Tentative Subdivision Map/Planned Development Permit and General Plan Amendment/Rezone 04-08 at its meeting of 7/17/07. Both subdivision maps are contiguous, and were analyzed as one project in the project EIR. Planned development overlay zoning districts were approved in conjunction with the rezone applications, with the PD overlay districts placed on lots proposed for multi-family residential development. The minimum number of dwelling units for both subdivisions was established by conditions of the respective planned development permits as follows:

Sycamore Glen:

124 apartment units

Mountain Vista:

133 apartment units

Mountain Vista:

13 townhomes 270 units, total

The developer (Pete Giampaoli of Epick Homes) has requested that 10 units be shifted from the Sycamore Glen map to the Mountain Vista map in order to make the multi-family residential density of both developments consistent (see attached letter of request). The total number of multi-family residential units

would not be reduced by the proposal.

Pursuant to CMC Section 19.28.090 and Section 19.30.060.A, the Planning Services Director may authorize as a minor change the requested shift of 10 multi-family residential units from the Sycamore Glen Subdivision to the Mountain Vista Subdivision, by making the following findings:

- 1. The modification is consistent with all applicable provisions of the Land Use and Development Regulations of the Chico Municipal Code.
- The modification does not involve a feature of the project that was a basis for findings in a negative declaration or environmental impact report for the project.
- 3. The modification does not involve a feature of the project that was specifically addressed or was a basis for conditions of approval for the project or that was a specific consideration by the Planning Commission and City Council in its approval of the project.
- The modification does not result in the deletion or negation of any mitigation measure imposed on the project; and
- 5. The modification will not result in an expansion in the scope or intensity of the use.

The Director has considered the request, and upon making the necessary findings, by this memorandum, approves it.

CC:

Pete Giampaoli, Epick Homes Bob Summerville, AICP, Senior Planner files: S/PDP 00-11 and S/PDP 01-12 EPICK, INC.
901 BRUCE ROAD, SUITE 280
CHICO, CA 95928
530.891,4757 PHONE
530.891,4206 FAX
CONTRACTORS LIC. NO. 663708

April 2, 2012



Mr. Mark Wolf, Planner Director

City of Chico PO Box 3420

Chico Ca 95927

RE:

Resolution 99-07

Sycamore Creek Subdivision Mountain Vista Subdivision

Dear Mark,

This letter seeks to clarify the number of apartments to be built at these subdivisons. We would like your written confirmation of units to be built as follows:

	Sycamore Creek	Mountain Vista	Total
Acres R-3	6.8	8.6	15.4
DUA	16.76	16.63	
R-3 Units	114	143	257
R-2 (Townhomes)	0	13	13
R-1	198	211	409
Total Units	312	367	679

The total number of units is the same as approved at 679. R-3 units approved were 257. Our understanding throughout the approval process was that the R-3 density was 16 DUA range. However the resolution places fewer units on Mountain Vista and more on Sycamore Creek making density above 18 DUA. This is too dense. We wanted more open space in both apartment projects. The allocation above moves more units to Mountain Vista thereby allowing project density in both projects at 16 DUA without reducing total number of approved units.

We appreciate your input. Please contact me should you wish to go over these numbers together.

Pete Giampaoli

cc: Bob Summerville Chris Giampaoli



LEFT ELEVATION 2

# MATERIAL / COLOR LEGEND

- 1 EXTERIOR PLASTER
- 2 COMPOSITE SLATS RAILING
- 3 BOARD AND BATTEN SIDING (FIBER CEMENT)
- 4 HORIZONTAL SIDING (FIBER CEM
- 5 VINYL WINDS
- 6 STUCCO OVER FOAM TRIM
- 7 COMPOSITION ROOF TILES
- 8 DECORATIVE LOUVERED VENT
- 9 DECORATIVE WOOD POST
- 10 DECORATIVE METAL MESH GRILLE
- 11 METAL SECTIONAL GARAGE DOOR



SEP 12 2018

CITY OF CITICO PLANNING SERVICES



FRONT ELEVATION 1



**BUILDING "A" ELEVATIONS** 

DATE: 09-10-2018 JOB NO.: 2018-369 A2.2

EATON RANCH

CHICO, CA

# RIGHT ELEVATION 4



REAR ELEVATION 3

**BUILDING "A" ELEVATIONS** 

A2.3 DATE: 09-10-2018 JOB NO.: 2018-369

MATERIAL / COLOR LEGEND

BOARD AND BATTEN SIDING (FIBER CEMENT)

EXTERIOR PLASTER COMPOSITE SLATS RAILING

STUCCO OVER FOAM TRIM COMPOSITION ROOF TILES DECORATIVE LOUVERED VENT DECORATIVE WOOD POST DECORATIVE METAL MESH GRILLE METAL SECTIONAL GARAGE DOOR

**EATON RANCH** 

CHICO, CA

ARCHITECTS ORANGE 144 NORTH ORANGE ST., ORANGE, CA 92866

(714) 639-9860 ORAN Attachment D

# MATERIAL / COLOR LEGEND

- 1 EXTERIOR PLASTER
- 2 COMPOSITE SLATS RAILING
- 3 BOARD AND BATTEN SIDING (FIBER CEMENT)
- 4 HORIZONTAL SIDING (FIBER CEMENT)
- 5 VINYL WIND
- 6 STUCCO OVER FOAM TRIM
- 7 COMPOSITION ROOF
- 8 DECORATIVE LOUVERED VENT
- 9 DECORATIVE WOOD I
- 10 DECORATIVE METAL MESH GRILLE
- 11 METAL SECTIONAL GARAGE DOOR



# SEP 12 20

CITY OF CHICO PLANNING SERVICES



FRONT ELEVATION 1



**BUILDING "B" ELEVATIONS** 

A3.2

EATON RANCH

CHICO, CA

DATE: 09-10-2018 JOB NO.: 2018-369

JOB NO.: 2018-369


S ORANGE
NGE, CA 92866
(714) 639-9860
Attachment D

Friday, September 07 2018 12 20 43 PM S:\2018\2018-369 CHANNEL EATON RD RESIDE



# MATERIAL / COLOR LEGEND

- 1 EXTERIOR P
- 2 COMPOSITE SLATS RAILING
- BOARD AND BATTEN SIDING (FIBER CEMENT)
- 4 HORIZONTAL SIDING (FIBER CEMENT)
- 5 VINYL WINDOWS
- 6 STUCCO OVER FOAM TRIM
- 7 COMPOSITION ROOF TILES
- 8 DECORATIVE LOUVERED VENT
- 9 DECORATIVE WOOD POST
- 10 DECORATIVE METAL MESH GRILLE
- 11 METAL SECTIONAL GARAGE DOOR

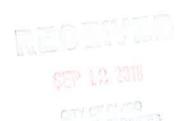



REAR ELEVATION 3



**BUILDING "B" ELEVATIONS** 

A3.3

EATON RANCH

CHICO, CA





LEFT ELEVATION 2



VINYL WINDOWS

STUCCO OVER FOAM TRIM

COMPOSITION ROOF TILES

BOARD AND BATTEN SIDING (FIBER CEMENT)

HORIZONTAL SIDING (FIBER CEMENT)

MATERIAL / COLOR LEGEND

B DECORATIVE LOUVERED VENT
 DECORATIVE WOOD POST

EXTERIOR PLASTER

COMPOSITE SLATS RAILING

10 DECORATIVE METAL MESH GRILLE

11 METAL SECTIONAL GARAGE DOOR

SIP 10 2018

1/8"=1'-0"

**BUILDING "C" ELEVATIONS** 

A4.2

EATON RANCH

CHICO, CA

DATE: 09-10-2018 JOB NO.: 2018-369



RIGHT ELEVATION 4

# MATERIAL / COLOR LEGEND

- 1 EXTERIOR PL
- 2 COMPOSITE SLATS RAILING
- 3 BOARD AND BATTEN SIDING (FIBER CEMENT)
- 4 HORIZONTAL SIDING (FIBER CEMENT)
- 5 VINYL WINDOWS
- 6 STUCCO OVER FOAM TRIM
- 7 COMPOSITION ROOF TILES
- 8 DECORATIVE LOUVERED VENT
- 9 DECORATIVE WOOD POST
- 10 DECORATIVE METAL MESH
- 11 METAL SECTIONAL GARAGE DOOR





PLANTING CONTROL



REAR ELEVATION 3



**BUILDING "C" ELEVATIONS** 

A4.3

EATON RANCH

CHICO, CA

DATE: 09-10-2018 JOB NO.: 2018-369



LEFT ELEVATION 2

# MATERIAL / COLOR LEGEND EXTERIOR PLASTER COMPOSITE SLATS RAILING BOARD AND BATTEN SIDING (FIBER CEMENT) HORIZONTAL SIDING (FIBER CEMENT) STUCCO OVER FOAM TRIM DECORATIVE LOUVERED VENT DECORATIVE METAL MESH GRILLE METAL SECTIONAL GARAGE DOOR



FRONT ELEVATION 1



**BUILDING "D" ELEVATIONS** 

DATE: 09-10-2018 JOB NO.: 2018-369

A5.2

**EATON RANCH** 

CHICO, CA

ARCHITECTS ORANGE

RIGHT ELEVATION 4

# MATERIAL / COLOR LEGEND

- 1 EXTERIOR PLASTER
- 2 COMPOSITE SLATS RAILING
- 3 BOARD AND BATTEN SIDING (FIBER CEMENT)
- 4 HORIZONTAL SIDING (FIBER CEMENT)
- 5 VINYL WINDO
- 6 STUCCO OVER FOAM TRIM
- 7 COMPOSITION ROOF TILES
- 8 DECORATIVE LOUVERED VENT
- 9 DECORATIVE WOOD POST
- 10 DECORATIVE METAL MESH
- 11 METAL SECTIONAL GARAGE DOOR





REAR ELEVATION 3



BUILDING "D" ELEVATIONS

A5.3

EATON RANCH

CHICO, CA

DATE: 09-10-2018 JOB NO.: 2018-369

# MATERIAL / COLOR LEGEND

- 1 EXTERIOR PLASTER
- 2 COMPOSITE SLATS RAILING
- BOARD AND BATTEN SIDING (FIBER CEMENT)
- 4 HORIZONTAL SIDING (FIBER CEME
- 5 VINYL WINDOV
- 6 STUCCO OVER FOAM TRIM
- 7 COMPOSITION ROOF TILES
- 8 DECORATIVE LOUVERED VENT
- 9 DECORATIVE WOOD PO
- 10 DECORATIVE METAL MESH GRILLE
- 11 METAL SECTIONAL GARAGE DOOR

EAST ELEVATION 2



NORTH ELEVATION 1



EATON RANCH I AMENITIES BUILDING ELEVATIONS


A7.2

- EXTERIOR PLASTER
- COMPOSITE SLATS RAILING
- BOARD AND BATTEN SIDING (FIBER CEMENT)

- STUCCO OVER FOAM TRIM
- DECORATIVE LOUVERED VENT
- DECORATIVE METAL MESH GRILLE
- METAL SECTIONAL GARAGE DOOR

WEST ELEVATION 4



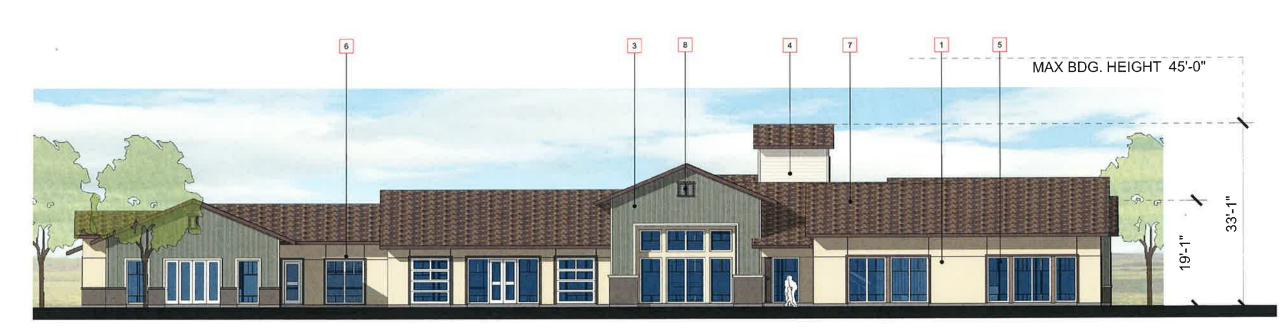

SOUTH ELEVATION 3



DATE: 09-10-2018 JOB NO.: 2018-369

EATON RANCH I AMENITIES BUILDING ELEVATIONS


A7.3

**EATON RANCH** 

CHICO, CA



# WEST ELEVATION 4

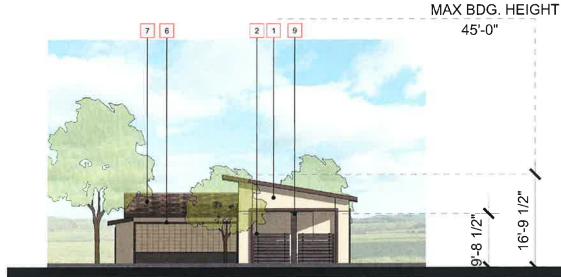

NORTH ELEVATION 2



MATERIAL / COLOR LEGEND

BOARD AND BATTEN SIDING (FIBER CEMENT)
HORIZONTAL SIDING (FIBER CEMENT)

EXTERIOR PLASTER


COMPOSITE SLATS RAILING

STUCCO OVER FOAM TRIM


COMPOSITION ROOF TILES

DECORATIVE LOUVERED VENT

DECORATIVE METAL MESH GRILLE
METAL SECTIONAL GARAGE DOOR

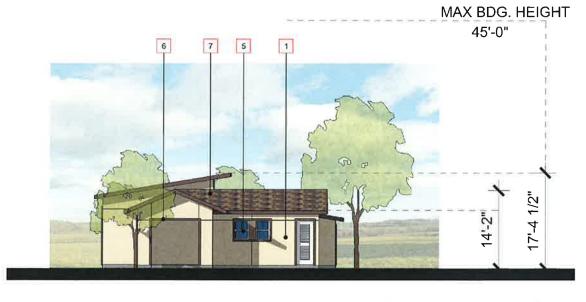

SOUTH ELEVATION 3

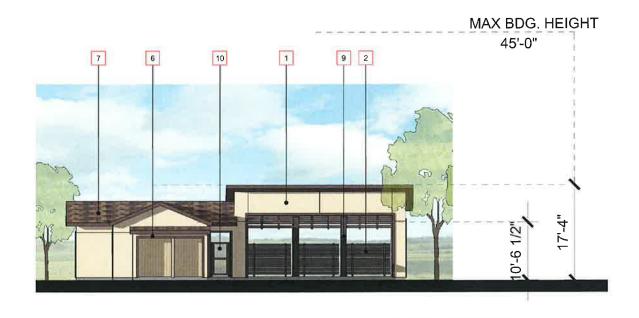

EAST ELEVATION 1



EATON RANCH I CABANA BUILDING ELEVATIONS

A7.5

EATON RANCH

CHICO, CA

DATE: 09-10-2018
JOB NO.: 2018-369
RCHITECTS ORANGE

Finday\_September 07\_2018 1;50:12 PM\_S.2018V2048\_369 CHICOSENTITION PROPERTIES CHICOSENTITIONS

C



0



© Dried Thyme SW 6186



Porpoise SW 7047

(E) Urbane Bronze SW 7048

Rookwood Medium Brown SW 2807

Exterior Plaster 20/30 Sand Finish - Paint Grade

Fiber Cement Wood Grain Railing Panels - Paint Grade

8 Composition Roof Shingles

Piber Cement Wood Grain Lap Siding - Paint Grade

(5) Vinyl Windows - White

3 Fiber Cement Wood Grain Vertical Siding - Paint Grade

Aesthetic White SW 7035



O Lotus Pod SW 7572



(7) Clear Glass



© Cobble Brown SW 6082



(L) Rookwood Medium Brown SW 2807

MATERIAL BOARD

DATE: 09-05-2018


JOB NO.: 2018-369

(714) 639-9860

**EATON RANCH** 

CHICO, CA


ARCHITECTS ORANGE 144 NORTH ORANGE ST., ORANGE, CA 92866

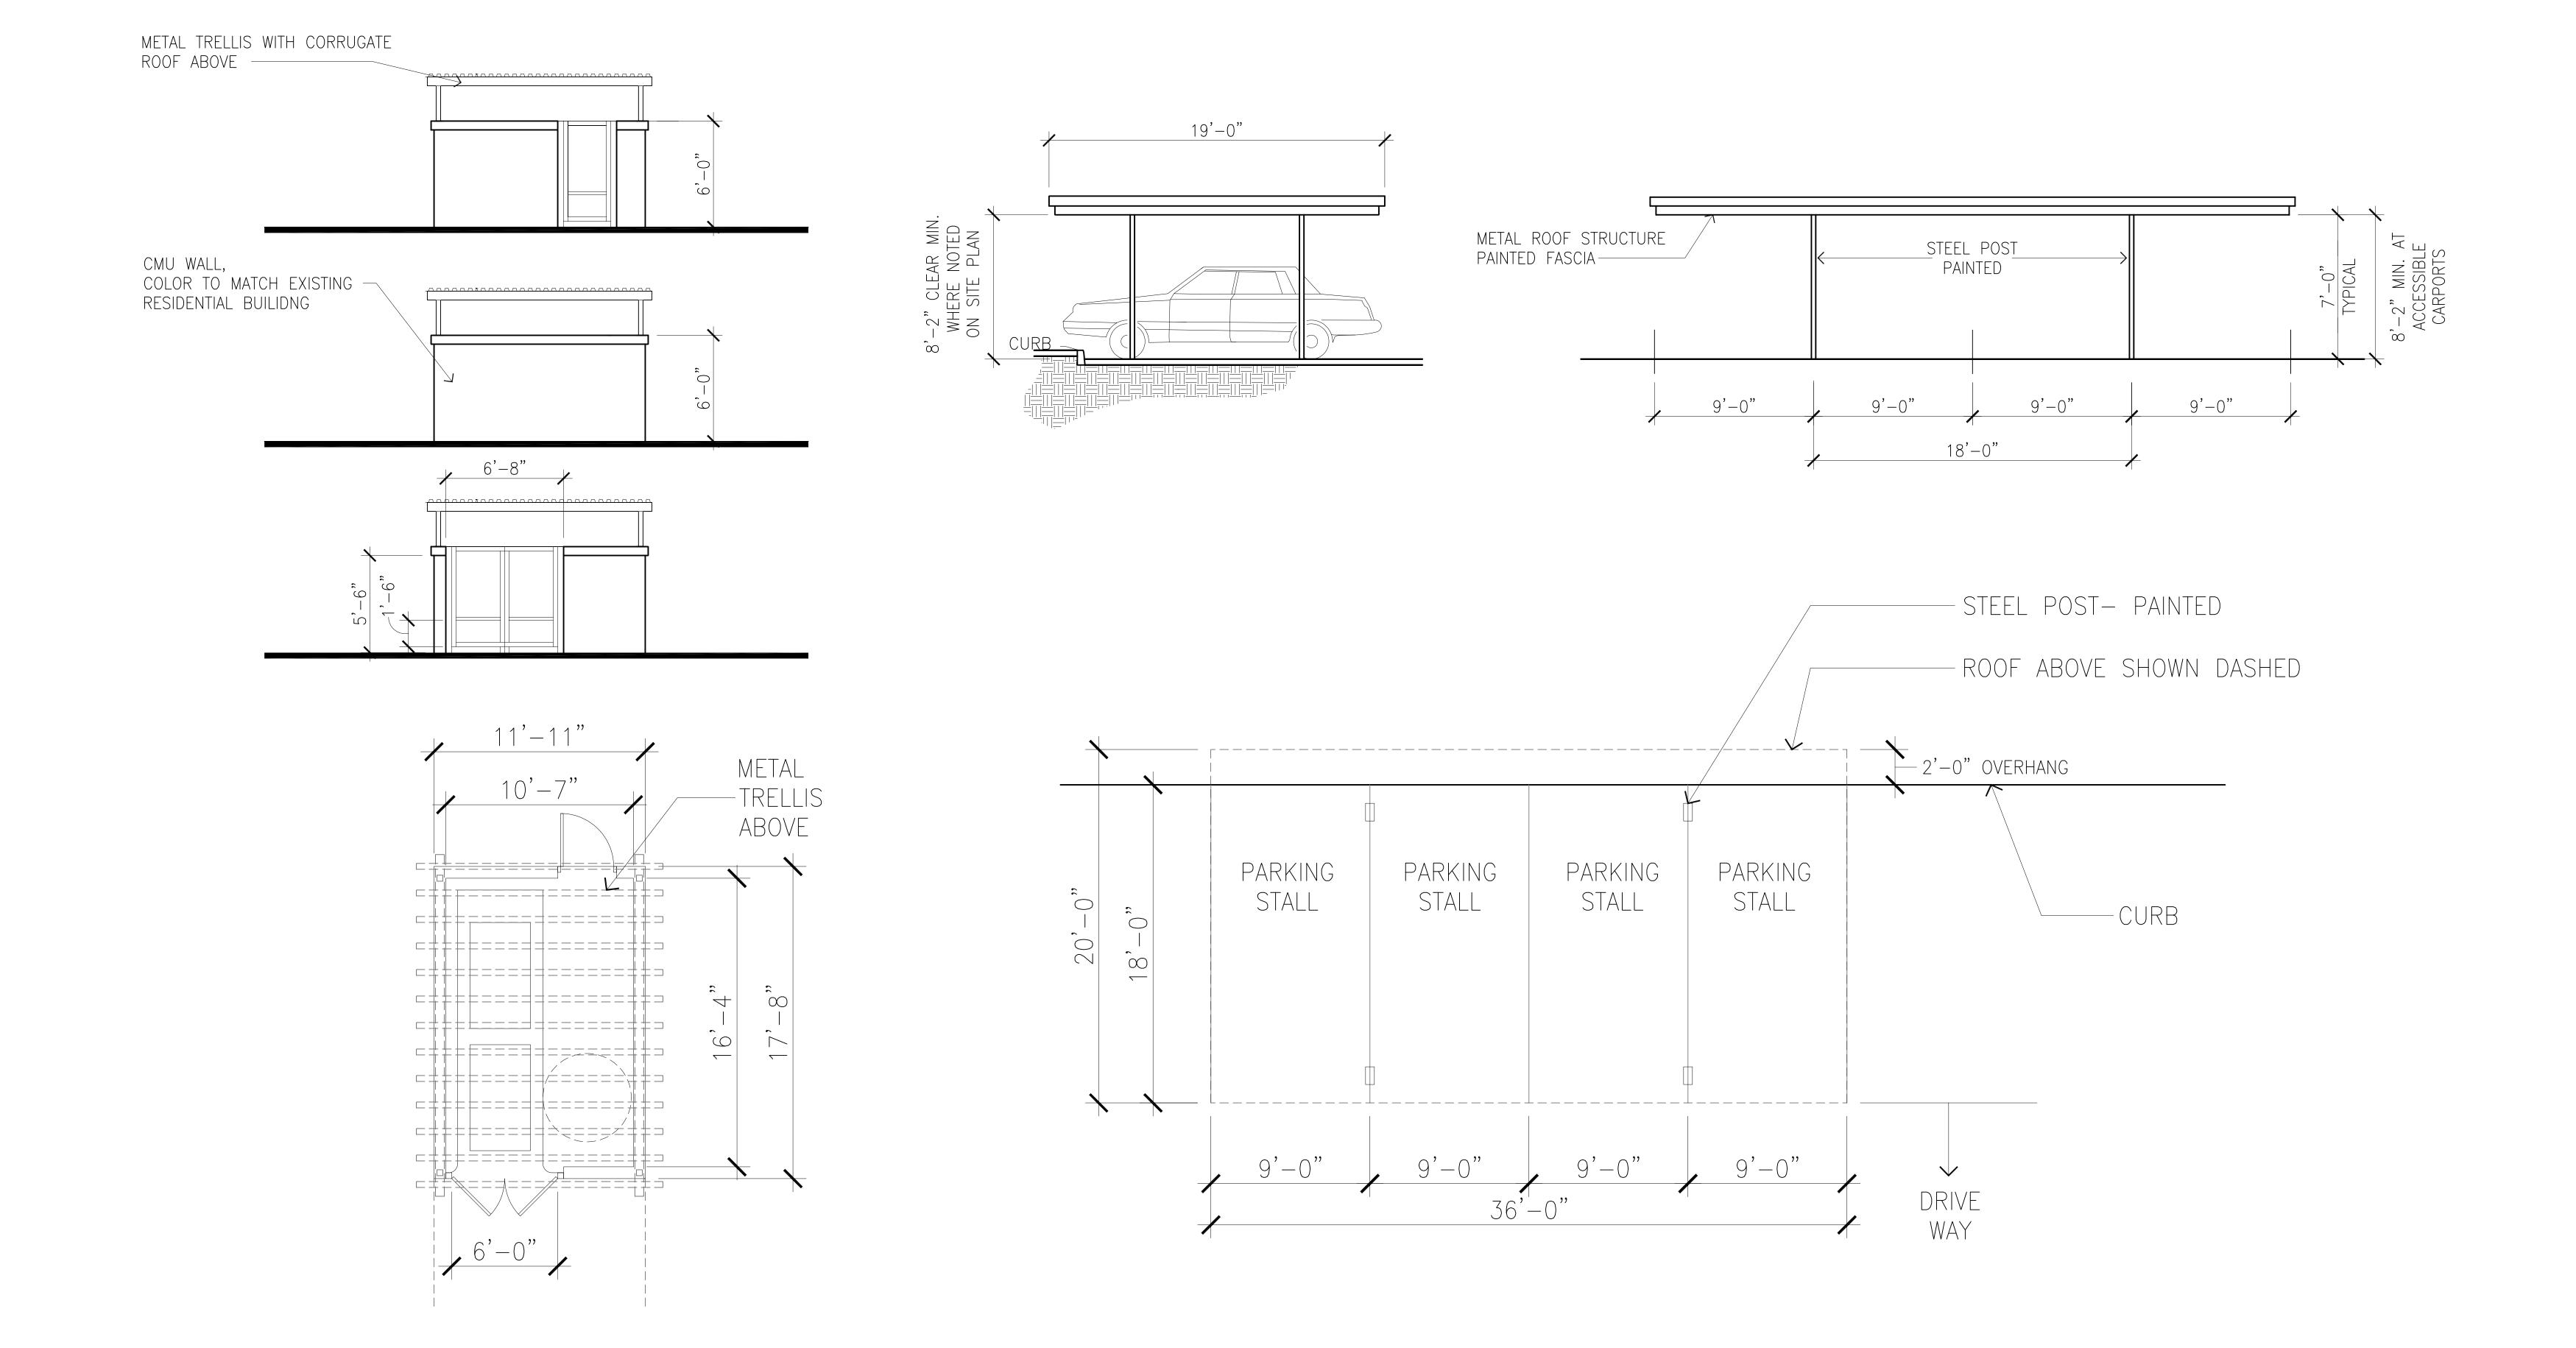



PARKING/CARPORT LAYOUT

0.8A

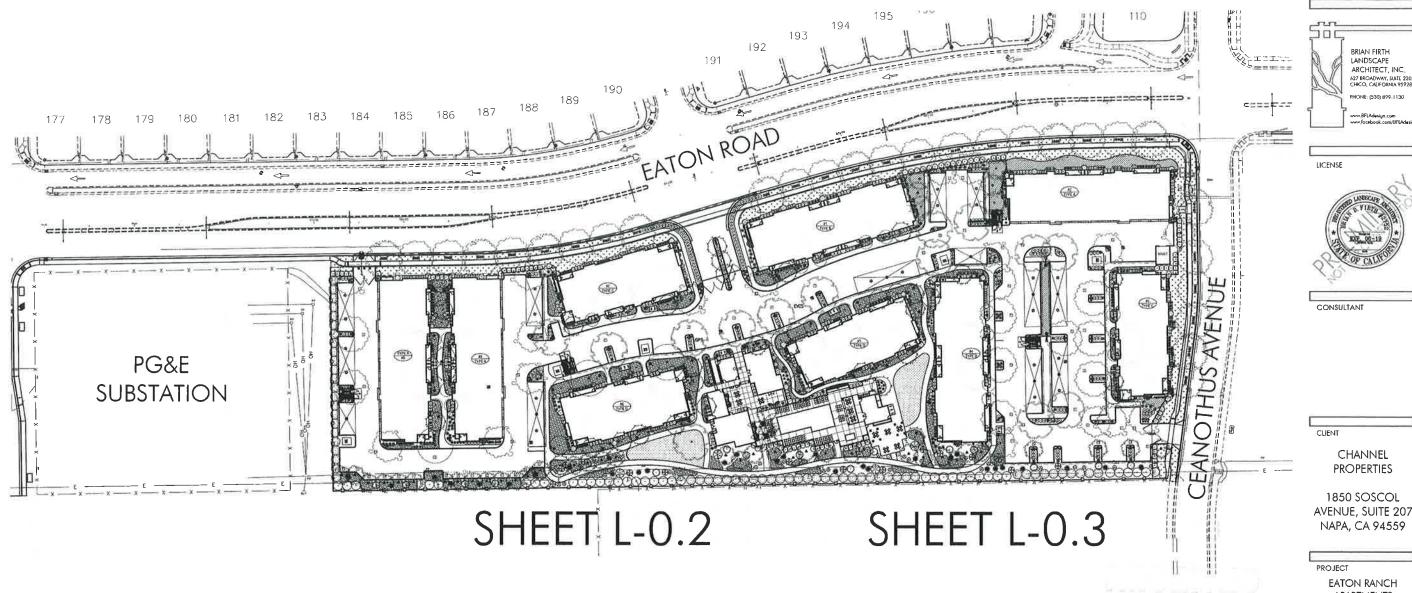

# PARKING LOT LANDSCAPE AREA

DESCRIPTION	AREA	PERCENT
TOTAL PARKING AND BACK-UP AREA	62,614 SF	
PARKING LOT LANDSCAPE AREA PROVIDED	5,840 SF	9%

# SHADE CALCULATIONS

DESCRIPTION			T	OTAL
GROSS PARKING AND B	7	8,098 SF		
MINUS CARPORT AREA	1.	5,483 SF		
TOTAL PARKING AND BA	ACK-UP AREA FOR CA	LCULATIONS	6	2,614 SF
SHADE AREA PROVIDED				
DESCRIPTION	SHADE AREA	QUANTITY	TOTAL	PERCENT
20 FOOT DIAMETER TRE	ES			
F FULL	314 SF	0	0	0
THREE QUARTER	235 SF	3	705 SF	1%
H HALF	157 SF	13	2,041 SF	3%
G QUARTER	78 SF	2	156 SF	0
40 FOOT DIAMETER TRE	ES			
F FULL	1,256 SF	8	10,048 S	16%
THREE QUARTER	942 SF	13	12,246 SI	19%
H HALF	628 SF	10	6,280 SF	10%
Q QUARTER	314 SF	5	1,570 SF	2%
TOTAL SHADE AREA PROV	/IDED		33,046 S	F 52%

# WATER USE CALCULATIONS

MAWA	A = (Eto) (0.7) (LA) (0.62)		
	a = 1,971,004 Galic		
lydrozone	5; Medium water use trees, shrub	s and ground cover; drip.	PR= 0.21
PF =	0.5		
	74,947 (square feet)	1.720546 Acres	
EWU =	0.9 1479203.957 (gallons per year)	4.53951 acre-feet/year	1977.545 ccf/year
	15; Cool season turf; rotator, roto		PR≃ 0.68
PF =	0.8		
HA =	4,311 (square feet)	0.098967 Acres	
IE =	417		
	175031.5269 (gallons per year) nated Water Use for All Hydro		233,9994 cct/year

# SOILS STATEMENT

STANDARD SOIL AMENDMENTS WILL BE APPLIED IN ACCORDANCE WITH

# LANDSCAPE IRRIGATION

LANDSCAPE IS PRIMARILY MEDIUM WATER USE PLANTINGS IRRIGATED BY MEANS OF AN AUTOMATICALLY CONTROLLED LOW VOLUME DRIP IRRIGATION SYSTEM. A PORTION OF THE LANDSCAPE WILL BE A HIGH WATER USE TURF AREA IRRIGATED BY MEANS OF AN AUTOMATICALLY CONTROLLED POP-UP ROTATOR SYSTEM.

THE IRRIGATION SYSTEM WILL UTILIZE A FLOW SENSING/ MASTER VALVE ASSEMBLY THAT WILL SHUT THE SYSTEM DOWN IN THE EVENT OF A LINE BREAK SO AS TO PREVENT WASTING WATER AND DAMAGE TO LANDSCAPE. IT WILL ALSO FEATURE AN EVAPOTRANSPIRATION/ RAIN/ FREEZE SENSOR WHICH ADJUSTS THE IRRIGATION SCHEDULE BASED UPON REAL-TIME CONDITIONS IN ORDER TO PROVIDE THE MINIMUM AMOUNT OF IRRIGATION FOR OPTIMAL PLANT GROWTH.

RECOMMENDATIONS BY AN ANALYTICAL SOILS TESTING LABORATORY.



CHANNEL **PROPERTIES** 

EATON RANCH **APARTMENTS** 

EATON AVENUE CHICO CA 95928

EATON RANCH II

PRELIMINARY LANDSCAPE PLAN

REFERENCE SHEET

SHEET TITLE


BRIAN FIRTH LANDSCAPE ARCHITECT, INC.

BFLA PROJECT #: 2056 CONSULTANT PROJECT # APN: 016-200-117 AND 016-340-03

● MANA Attachment H

SCALE: NO SCALE

OCT 31 2018

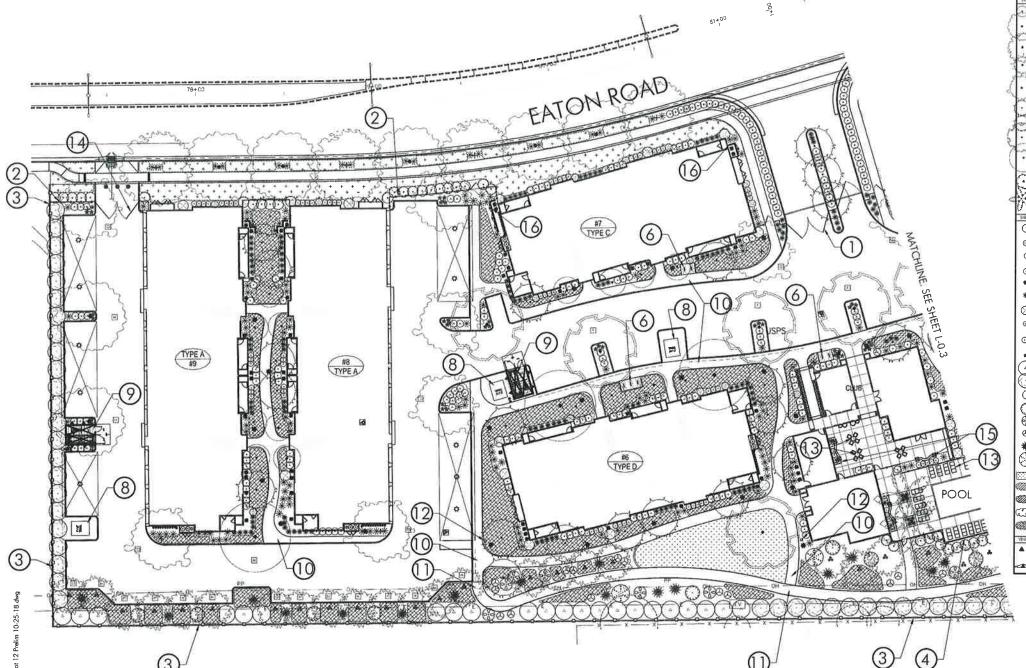

# DI ANIT LICT

### ### ### ### ### ### ### ### ### ##	THES	COMMONTANE	CONTRACT	divility	RAMAGS	WOLDER US
PRINCE CONTROL   15 CAL   15 STACAND   1600   1600   160	(A)	ACER PALIVATUM BLOODISCOOD	24 BCX	29	STANDARD	MEDERN
The Color of the	•	UMISPAPARCEA	S GAL	21	OSFA-NV.5	1
PARS CANADERISS CONTROL TO THE CONTR	2					1
CAMERICAN PARTS	;	COVERCUS SOLER SCORE CIME	15 GAL	tt.	STANDARD	MEDRIM
MAILTO ONC	7	PINUS CANARETISIS CANARY ISLAND PINE	15 G/4	- 6	SIAMMAD	fow
LAGESTROPHAN FORCH TUSCARONA TUSCARONA   19704   16   51   51   51   51   51   51   51	.)	QUERCUS LOBATA VALLEY OAK	15 GAL	17	214HC44D	LOW
15 GAL   11   15 GAL   11   15 GAL   12   15 GAL   16 G	•)	LAGERSTROEMIA INDICA FREBRITY RED PLOWERING CRAPE MYRTLE	74 BOs	24	STANDARD	LOW
15 CM	3	LAGERSTROEMA INDICA TUSCARORA TUSCARORA CRAPE MYRTIE	24 904	116	CNAGRATZ	10m
SQUARTERS PROGRAMS   15 QU   37   STANDARD   MEDIAN   SWEET CLINE   SW	-5	PRITADESI CHERENS'S KERTH DAVEY	15 GAL	136	CSAGMATZ	LOW
VASCIDITIONAN ACRUSTA   12 HBGHF   97   STANDARD   MEDIUM   MEDI	•	CHICAS COCCHEA	15 GAL	1.65	STAHCARD	WEDLAL
Mail-Primer Trans Primer   Mail-Primer   M	O	OSMANTIKUS FRAGRANS SWEET OLIVE	18 G/4	37	STANDARD	PAEDRURA
Validation Trials States Bodgett States	K	WASHINGTONNA BOPUSTA MENCANI FAN PAUX	12° HEIGHT	:20	STANDARD	NEGRAIA
© CAMBINI MANNELLY COLORIDA  SANNOLLY COMPLIA  COSA PONTROM  CONTROM  CONT	_		1 400			METRON
SANONIC COMPILED	_			34		
GOLOPOCOPR ROSE RETU  SAMPHINE PROCESSAS PROCE		SASANGUA CAVELLIA				
O	0	GROLINDCOVER ROSE (RED)				
Introduction   International   Internation	0	SPRINGTIME INDIA HAWTHORN				MECHUM
© PODOCARIS M JUMI         3 04         41         MAGRAM           9 PUBBST VERY WHEN         1 04         162         10W           0 LOW OFFICE SANDERS         1 04         162         10W           0 LOW OFFICE SANDERS         3 04         277         MEDIAN           0 LOW OFFICE SANDERS         1 04         31         ADDIAN           1 HUNGOLD HINTO         1 04         33         MEDIAN           1 PROBLEM A FEMBIN         5 04         38         MEDIAN           1 PROBLEM A FEMBIN         5 04         39         MEDIAN           1 PROBLEM A FEMBIN         5 04         59         MEDIAN           1 PROBLEM A FEMBIN         5 04         50         10W           1 PROBLEM A FEMBIN         5 04         59         MEDIAN           2 PROBLEM A FEMBIN         5 04         59         MEDIAN           2 PROBLEM A FEMBIN         5 04         15         10W           2 PROBLEM A FEMBIN         5 04         10W         10W		U(Y-QF-THE-PALE	164	316		MAEDAM
1 GAL   162   162   164   162   164   162   164   162   164   162   164   162   164   162   164   164   16	*	DIETES BICOLOR FORTHIGHT ULY/AKOPREA ULY	I GAL	346		row
DOMESTIC PROPRIES   DOMESTIC PROPRIES	$\otimes$	PODOCARPUS M. MAKI SHRUBBY YEW PAHE	5 GAL	40		MEDIUM
COMMAND CONSTRUCTION   CONTROL   C	0	HARIONA EGMESTICA COMMICTA COMMICT RESTENY EMMICIO	I GAL	162		LOW
PRODUCT PROVIDED   10	0	LOROPETALUM CHINENSE WAZZ HANDS COMPACT LOROPETALUM	5 GAL	279		MEDIKAN
PRACES PROTEINA   10   1500   1000   1000   *	HENDROCKLIS HISE D DISTRIBUTION DAY DELT (FLOWER COLOR FER DWINER)	1 GAL	318		MEDIUM
MIRAS PURPOCESAUS   50		PHOTINIA X FRASERI	5 GAL	38		MEDIUM
MOSTLORIPULA   15   15   16   16   16   16   16   16		PRURIUS LAUROCERASUS	S GAL	59		MED-UM
TAUTHONOCOSSUS TRICSPOATA   1 GM	Õ	GREVILLEA X NOELL' NOELL GREVILLEA	5 GAL	90		1094
TAUTHONOCOSSUS TRICSPOATA   1 GM	$\bigcirc$	ARCFOSTAPHYLOS HOWARD MOMENS MOMENN MANZANITA	5 GAL	15		(CW
200   1.000   1.000   FLUMBAGO AURICULATA	5 CAL	15		LOW
Multi-Rescou Roels   1 GN   30   100   100   1	0	ZAUSCHINERIA GALIFORNICA	1 GAL	30	1	low
Color	*	MUHLENBERGIA INGENS	I GAL	30		LOW
TACHELOFEMAN MANAGODES		CERCIS OCCIDENTALIS	5 GAL	3.		tow
TACHELOFEMAN MANAGODES			500	4,311 SF	-	HGH
1 GM	7770	TRACHELOSPERMUM JASMINORDES STAB LISTABLES	1 GU	4,291 SF	PANT @ 36" O.C.	MEDIUM
1 OA	200	TEUCRUM CHAMAEORYS FROSTRATUM	194	574 SF	RANT @ 36" O C	LOW
### ANTHENCESUS TRICSPOATA   1 GM	روند	ALMMERUS CONFERTA SHOWN ALMMERS	1 GAL	15,022 SF	FLANT @ 36' O.C.	LOW
APATHENOCISSUS TRICSPIDATA IGN. 17 TRAIN TO TRAIN BOSTON NY ROMAN BOSTON NY			1 (3.4)	16,0 <b>37</b> SF	MAN1 (3 36 O.C.	MEDIAM
BOSTON MY ENCLOSURE		PAPINANCESTRESPIDATA	100	17	TIAN TO	MEDILM
	_ ;	N NOTZOE			ENCLOSURE	MEDIUM

# BRIAN FIRTH LANDSCAPE ARCHITECT, INC. PHONE (530) 899-1130

LICENSE



CONSULTANT

CHANNEL **PROPERTIES** 

1850 SOSCOL AVENUE, SUITE 207 NAPA, CA 94559

PROJECT

EATON RANCH **APARTMENTS** 

EATON AVENUE CHICO CA 95928

SHEET TITLE EATON RANCH II PRELIMINARY LANDSCAPE PLAN 20 SCALE

DATES
NO DESCRIPTION DATE
1 REVIEW SUBMITTAL 9-19-18
SITE REVISIONS 10-30-18

#### PLAN LEGEND SYMBOL DESCRIPTION

LIGHTING SYMBOLS

CARPORT LED LIGHT

LED BOLLARD LIGHT

LED AREA LIGHT 14' LUMINERE HEIGHT WITH GLARE CUT-OFFS AS REQUIRED TO PREVENT LIGHT FROM SHINING ONTO ADJACENT PROPERTIES

SYMBOL DESCRIPTION

	DESGRIP HOLY
0	ENTRY GATE
0	SIX FOOT HIGH, BLACK, TUBULAR STEEL FENCING
3	SIX FOOT HIGH, BOARD ON BOARD FENCE WITH CAP
4	POOL FENCING
3	SHADE TRELLIS
0	GUEST BICYCLE PARKING. TYPICAL SYMBOL
0	PG & E ACCESS GATES (12 FOOT MINIMUM WIDTH)
8	TRANSFORMER LOCATION
9	TRASH ENCLOSURE (BY OTHERS)
0	CONCRETE WALKWAY
0	ASPHALT WALKWAY
0	DOGGIE WASTE STATION
(3)	SITE FURNISHING, PER OWNER.
<b>(4)</b>	EMERGENCY ACCESS GATE BY OTHERS
(3)	CONCRETE SEATWALL WITH PLANTING CONTAINERS. FORM BOARD FINISH
0	HVAC/ UTILITY SCREEN PANEL TYPCTAL AT ALL HVACS/ UTILITIES FACING PUBLIC VIEW.

Plot Date: October 30, 2018 - 11:52 an

PROJECT NUMBERS BFLA PROJECT #: 2056 CONSULTANT PROJECT #: APN: 016-200-117 AND 016-340-034


SHEET NUMBER

L-0.2

Attachment H

OCT 31 2018

SCALE: 1"= 20'-0"

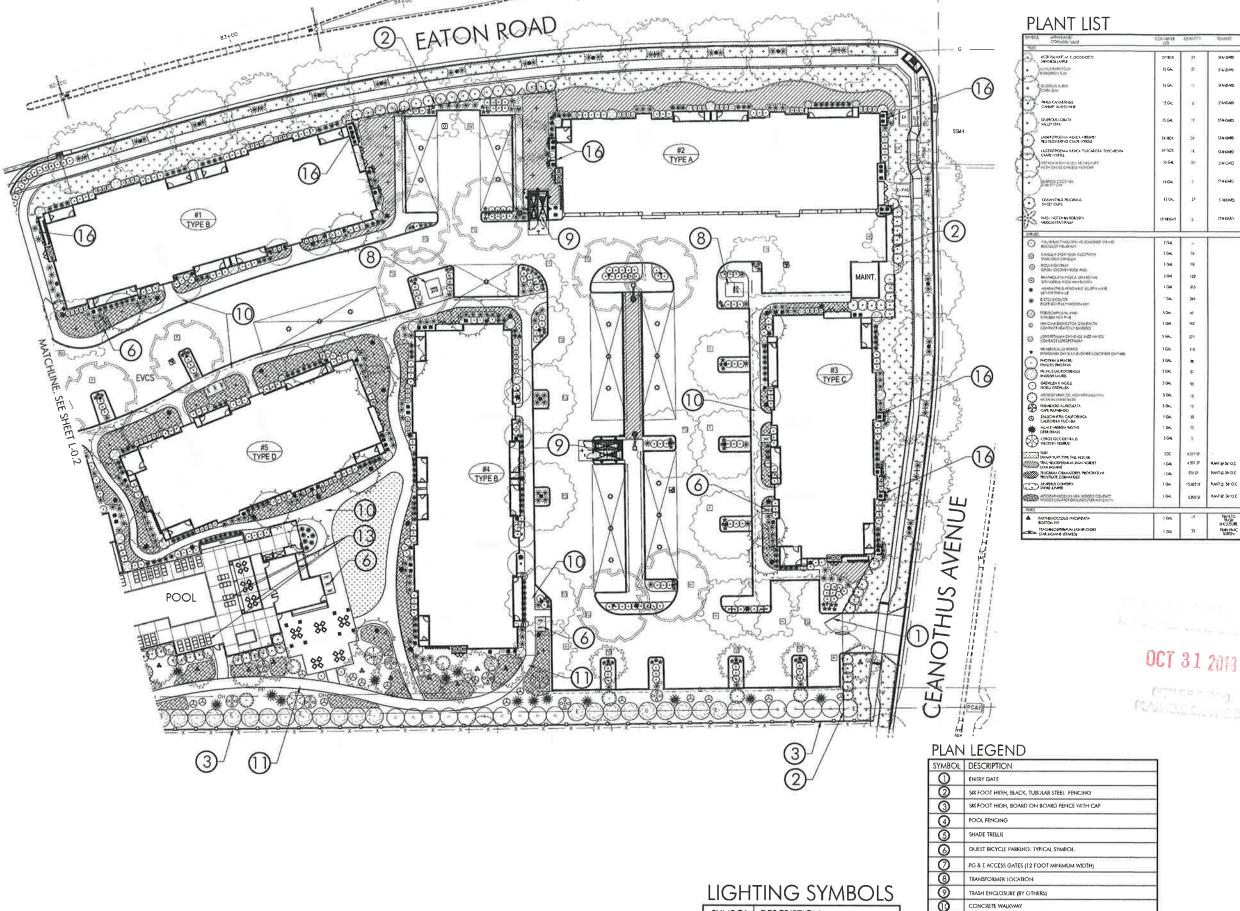

SYMBOL	DESCRIPTION
۵	CARPORT LED LIGHT
*	LED BOLLARD LIGHT
I	LED AREA LIGHT 14' LUMINERE HEIGHT WITH GLARE CUT-OFFS AS REQUIRED TO PREVENT LIGHT FROM SHINING ONTO ADJACENT PROPERTIES



CONCRETE SEATWALL WITH PLANTING CONTAINERS, FORM BOARD FINISH HVAC/ UTILITY SCREEN PANEL TYPICIAL AT ALL HVACS/ UTILITIES FACING

L-0.3

Attachment H

SCALE: 1"= 20'-0"

OCT 31 2010

SHEET TITLE EATON RANCH II PRELIMINARY

LANDSCAPE PLAN 20 SCALE

CHANNEL

**PROPERTIES** 

1850 SOSCOL

**AVENUE, SUITE 207** 

NAPA, CA 94559

EATON RANCH

**APARTMENTS** 

EATON AVENUE CHICO CA 95928

PROJECT

BRIAN FIRTH LANDSCAPE ARCHITECT, INC.

PHONE: (530) 899-1130

LICENSE

CONSULTANT

DATES NO DESCRIPTION REVIEW SUBMITTAL SITE REVISIONS

Plot Date: October 30, 2018 - 11:52 am

PROJECT NUMBERS BFLA PROJECT # 2056 CONSULTANT PROJECT #: APN: 016-200-117 AND 016-340-034

SHEET NUMBER









BRIAN FIRTH LANDSCAPE ARCHITECT, INC. PHONE: (530) 899-1130

LICENSE



CHANNEL **PROPERTIES** 

1850 SOSCOL **AVENUE, SUITE 207** NAPA, CA 94559

> EATON RANCH **APARTMENTS** EATON AVENUE

CHICO CA 95928

EATON RANCH II PRELIMINARY LANDSCAPE DESIGN DEVELOPMENT

 DATES

 NO
 DESCRIPTION
 DATE

 1
 REVIEW SUBMITTAL SITE REVISIONS
 9-19-18 10-30-18

PROJECT

SHEET TITLE

CONSULTANT



HVAC/ UTILITY SCREEN PANEL (WITH EVERGREEN VINE TRAINED TO PANEL)

TUBULAR STEEL FENCING

BICYCLE RACK

DOGGY WASTE TABLES AND CHAIRS **STATION** 




**CARPORT** 







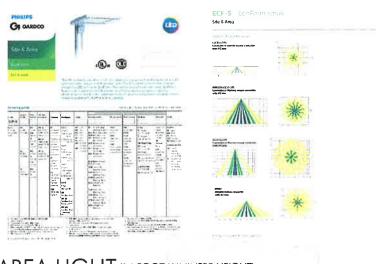

AREA LIGHT (14 FOOT LUMINERE HEIGHT)

OCT 31 2018





**BOLLARD LIGHT** 






ENTRY SIGNAGE

Plot Date: October 30, 2018 - 11:52 am

PROJECT NUMBERS BFLA PROJECT #: 2056 CONSULTANT PROJECT #: APN: 016-200-117 AND 016-340-034

SHEET NUMBER

L-0.4

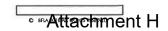

POOL

BOARD ON BOARD FENCE

SHEET L-0.3

PARKING LOT LANDSCAPE AREA

SHEET L-0.2

DESCRIPTION	AREA	PERCENT
TOTAL PARKING AND BACK-UP AREA	73,742 SF	
PARKING LOT LANDSCAPE AREA PROVIDED	8,052 SF	10%

# SHADE CALCULATIONS

DESCRIPTION			T-	OTAL
GROSS PARKING AND I	92	2,740 SF		
MINUS CARPORT AREA	18	3,998 SF		
TOTAL PARKING AND B	ACK-UP AREA FOR CA	alculations	73	3,742 SF
SHADE AREA PROVIDED				
DESCRIPTION	SHADE AREA	QUANTITY	TOTAL	PERCENT
20 FOOT DIAMETER TRI	EES			
F FULL	314 SF	0	0	0
THREE QUARTER	235 SF	4	940 SF	1%
H HALF	157 SF	5	785 SF	1%
Q QUARTER	78 SF	4	312 SF	<1%
40 FOOT DIAMETER TR	EES .	II		-
F FULL	1,256 SF	11	13,816 SF	18%
TO THREE QUARTER	942 SF	9	8,478 SF	11%
H HALF	628 SF	11	6,280 SF	8%
Q QUARTER	314 SF	20	6,280 SF	8%
TOTAL SHADE AREA PRO	VIDED		36,891 SF	50%

# WATER LISE CALCULATIONS

MAWA	= (Eto) (0.7) (LA) (0.62)		
MAWA	= 2,863,126 Gallo	ons per Year	
lydrozone :	5; Medium water use trees, shrut	s and ground cover; drip.	PR= 0.21
PF =	0.5		
	110,120 (square feet)	2.528007 Acres	
	0.9		
EWU =	2173401,733 (gallons per year)	6.669925 acre-feet/year	2905.617 cc#year
lydrozone '	15; Cool season turf; rotator, roto		PR= 0.68
PF =	8,0		
HA =	5,012 (square feet)	0,11506 Acres	
!E =			
EWU =	203492.928 (gallons per year)	0.624497 acre-feet/year	272.0494 cct/year

# SOILS STATEMENT

STANDARD SOIL AMENDMENTS WILL BE APPLIED IN ACCORDANCE WITH RECOMMENDATIONS BY AN ANALYTICAL SOILS TESTING LABORATORY.

SHEET L-0.4

# LANDSCAPE IRRIGATION

MEANS OF AN AUTOMATICALLY CONTROLLED LOW VOLUME DRIP IRRIGATION SYSTEM. A PORTION OF THE LANDSCAPE WILL BE A HIGH WATER USE TURF AREA IRRIGATED BY MEANS OF AN AUTOMATICALLY CONTROLLED POP-UP ROTATOR SYSTEM.

ASSEMBLY THAT WILL SHUT THE SYSTEM DOWN IN THE EVENT OF A LINE BREAK SO AS TO PREVENT WASTING WATER AND DAMAGE TO LANDSCAPE. IT WILL ALSO FEATURE AN EVAPOTRANSPIRATION/ RAIN/ FREEZE SENSOR WHICH ADJUSTS THE IRRIGATION SCHEDULE BASED UPON REAL-TIME CONDITIONS IN ORDER TO PROVIDE THE MINIMUM AMOUNT OF IRRIGATION FOR OPTIMAL PLANT GROWTH.

LANDSCAPE ARCHITECT, INC.



CONSULTANT

CHANNEL **PROPERTIES** 

1850 SOSCOL **AVENUE, SUITE 207** NAPA, CA 94559

EATON RANCH **APARTMENTS** 

EATON AVENUE CHICO CA 95928

> SHEET TITLE EATON RANCH I PRELIMINARY LANDSCAPE PLAN REFERENCE SHEET

REVIEW SUBMITTAL 9-19-18 SITE REVISIONS 10-30-18

PROJECT NUMBERS BFLA PROJECT # 2056 CONSULTANT PROJECT #

SHEET NUMBER

OCT 31 2018


PLANETAU CONTESS

Attachment H

LANDSCAPE IS PRIMARILY MEDIUM WATER USE PLANTINGS IRRIGATED BY

THE IRRIGATION SYSTEM WILL UTILIZE A FLOW SENSING/ MASTER VALVE

SCALE: NO SCALE

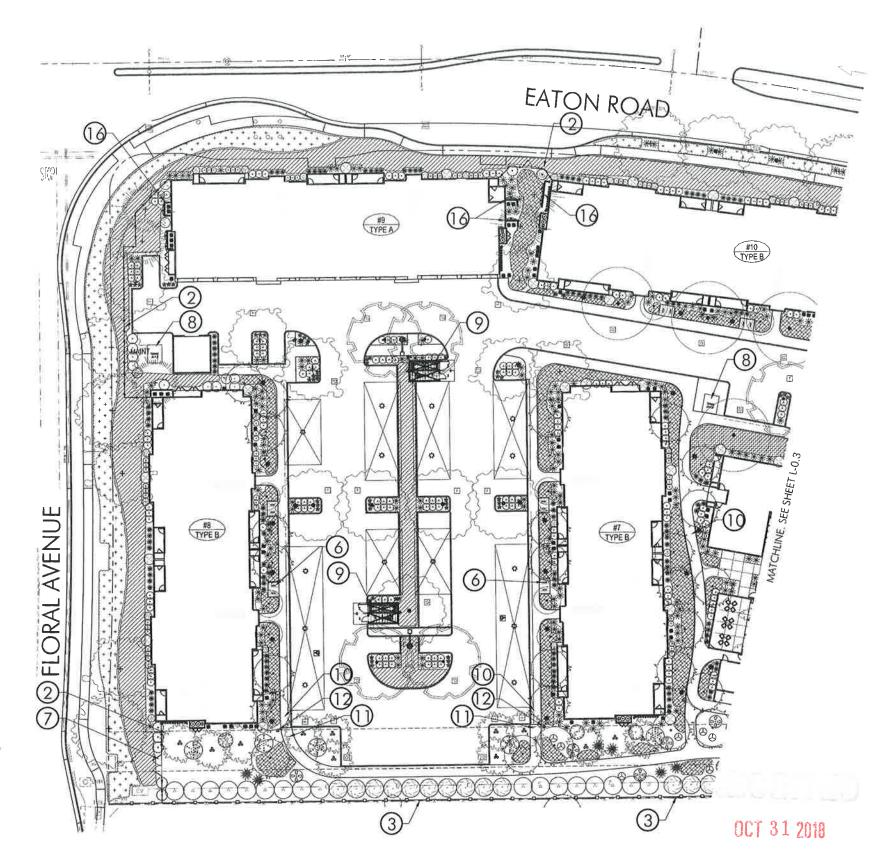

provine average Flake the business

# LIGHTING SYMBOLS

SYMBOL	DESCRIPTION
۵	CARPORT LED LIGHT
*	LED BOLLARD LIGHT
	LED AREA LIGHT 14' LUMINERE HEIGHT WITH GLARE CUT-OFFS AS REQUIRED TO PREVENT LIGHT FROM SHINING ONTO ADJACENT PROPERTIES

# PLANT LIST

SYMBOL	LATIN NAME/ COMMON NAME	CONTAINER SIZE	QUANTITY	REMARKS	WATER USI
THEES	ACER PALMATUM BLOODGOOD	Oct BOW	20	Classon	
CA,	JAPANESE MAPLE	24° BOX	28	STANDARD	MEDIUM
· ·	ULAUS PARVIFOLIA EVERCREEN ELA	15 GAL	22	STANDARD	MEDIUM
•	QUERCUS SUBER	15 GAL	14	STANDARD	MEDITUM
7	PINUS CANARIENSIS CANARY ISLAND PINE	15 GAL	16	STANDARD	row
. }	QUERCUS LOBATA VALLEY OAK	I5 GAL	21	STANDARD	LOW
.)	LAGERSTROEMIA INDICA, FIREDIRD' RED FLOWERING CRAPE MYRTLE	24' BOX	28	STANDARD	ſO₩
2	LAGERSTROEMIA IND:CA TUSCARORA: TUSCARORA CRAPE MYRTLE	24' BOX	34	STANDARD	LOW
-5	PISTACHIA CHINENSIS KEITH DAVEY KEITH DAVIES CHINESE PISTACHE	15 GAL	13	STANDARD	row
•	SAERCUS COCCRIEA CORETT OV	15 GAL	16	STANDARD	MEDIUM
0	OSMANTHUS FRAGRANS SWEET OLIVE	24° BOX	31	SIANDARD	MEDIUM
K	WASHINGTONIA ROBUSTA MEXICAN FAN PALM	12 HEIGHT	4	STANDARD	MEDIUM
SHALISS	v				
$\odot$	VIBURNUM TINUS "SPRING BOUQUET SPRING BOUQUET VIBURNUM	5 GAL	44		MEDIUM
(3)	CAMELLIA SASANGUA CLEOPATRA SASANGUA CAMELLIA	5 GAL	53		MEDIUM
0	ROSA NOATRUM GROUNDCOVER ROSE (RFD)	1 GAL	82		MEDIUM
<b>(</b>	RHAPHIOLEMS INDICA SPRINGTIME	5 GAL	156		MEDIUM
*	SPRINGTIME INDIA HAWTHORN AGAPANTHUS AFRICANUS QUEEN ANNE	I GAL	384		MEDAUM
*	ULY OF THE NILE DIETES BICOLOR FORTNIGHT LILY/MORREA HLY	1 GAL	508		LOW
$\otimes$	PODOCARPUS M MAKI SHRUBBY YEVY PINE	5 GAL	50		MEDIUM
0	NANDINA DOMESTICA COMPACTA' COMPACT HEAVENLY BAMBOO	1 GAL	196		LOW
0	LOROPETALUM CHINENSE JAZZ HANDS' COMPACT LOROPETALUM	5 GAL	326		MEDIUM
*	HEMEROCALLIS HYBRID EVERGREEN DAYDIJLY (FLOWER COLOR PER OWNER)	1 GAL	136		MEDIUM
()	PHOTINIA X FRASERI FRASERS PHOTINIA	5 GAL	65		MEDIUM
	PRUNUS LAUROCERASUS ENGLISH LAUREL	5 GAL	53		MEDIUM
ŏ	GREVILLEA X HOELL' NOELL GREVILLEA	5 GAL	69		LOW
	ARCTOSTAPHYLOS HOWARD MCMINN MCMINN MANZANITA	5 GAL	8		IO/A
ě.	PLUMBAGO AURICULATA CAPE PLUMBAGO	5 GAL	12		LOW
0	ZAUSCHNERIA CALIFORNICA CALIFORNIA FUCHSIA	1 GAL	22		LOW
*	MUHLENBERGIA RIGENS DEER GRASS	1 GAL	18		LOW
	DEER GRASS  CERCIS OCCIDENTALIS WESTERN REDBUD	5 GAL	12		LOW
	TURF DWARF TURF TYPE TALL FESCUE	SOD	5,012 SF		HIGH
	TRACHELOSPERMUM JASMINOIDES STAR JASMINE	1 GAL	17,887 SF	PLANT @ 36' O.C	MEDIUM
m	TEUCRIUM CHAMAEDRYS PROSTRATUM PROSTRATE GCESSAVIDER	I GAL	2,04) SF	PLANT @ 36 O.C.	row
المثيث	JUNIPERUS CONFERTA SHORF JERNPER	I GAL	13,130 SF	PLANT @ 36" O.C.	LOW
-000	ARTOSTAPHYROS UNA URSE WOODS COMPICET WOODS COMPACT GROUNDCOVER MANZANITA	I GAL	20,034 SF	PLANT @ 36" O.C	MEDIUM
	MOCOS COMMCT ORCONIACOMICTIMATANTA				
	WOODS COMPACT ORDUNACOME INVENTAGE				
<i>180</i> 0	PARTHENOCISSUS TRICSPIDATA BOSTON IV	I GAL	10	TRAIN TO TRASH ENCLOSURE	MEDIUM

# PLAN LEGEND

SYMBOL	DESCRIPTION
0	ENTRY GATE
2	SIX FOOT HIGH, DIACK, TUBULAR STEEL FENCING
3	SIX FOOT HIGH, BOARD ON BOARD FENCE WITH CAP
4	POOL FENCING
(3)	SHADE TREILIS
0	GUEST BICYCLE PARKING TYPICAL SYMBOL
7	PG & E ACCESS GATES (12 FOOT MINIMUM WIDTH)
<b>®</b>	TRANSFORMER LOCATION
0	TRASH ENCLOSURE (BY OTHERS)
0	CONCRETE WALKWAY
0	ASPHALT WALKWAY
12	DOGGIE WASTE STATION
(3)	SITE FURNISHING, PER OWNER.
<b>(4)</b>	EMERGENCY ACCESS GATE. BY OTHERS
(3)	CONCRETE SEATWALL WITH PLANTING CONTAINERS, FORM BOARD FINISH
<b>@</b>	HVAC/ UTILITY SCREEN PANEL TYPCIAL AT ALL HVACS/ UTILITIES FACING PUBLIC VIEW



BRIAN FIRTH
LANDSCAPE
ARCHITECT, INC.
627 BROADWAY, SUITE 220
CHICO, CALIFORNIA 9592B
PHONE (530) 899, 1130

LICENSE



CONSULTANT

CLIENT

CHANNEL PROPERTIES

1850 SOSCOL AVENUE, SUITE 207 NAPA, CA 94559

PROJECT

EATON RANCH APARTMENTS

EATON AVENUE CHICO CA 95928

SHEET TITLE
EATON RANCH I
PRELIMINARY
LANDSCAPE PLAN
20 SCALE

DAT	ES	
NO	DESCRIPTION	DAT
1	REVIEW SUBMITTAL	9-19-1
	CITE DEVIEWANTE	10 20 1


Plot Date: October 30, 2018 - 2:31 pm

PROJECT NUMBERS
BFLA PROJECT #: 2056
CONSULIANT PROJECT #:
APN: 016-200-117 AND 016-340-034

SHEET NUMBER

L-0.2

Attachment H

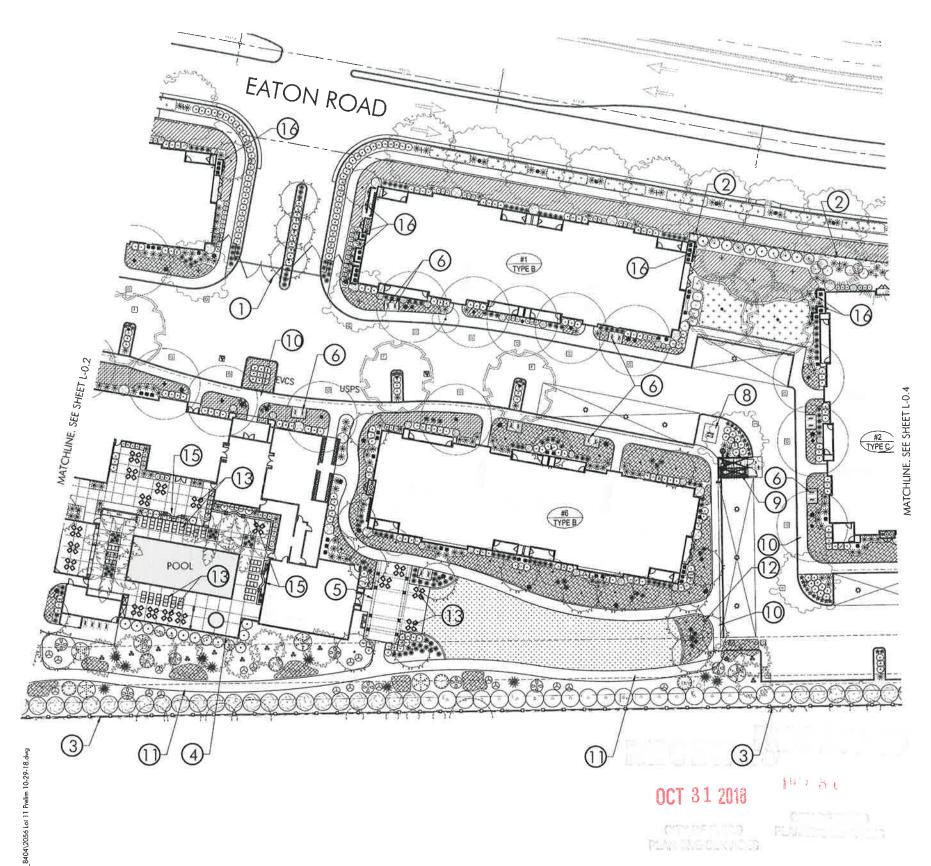

# LIGHTING SYMBOLS


SYMBOL	DESCRIPTION
ø	CARPORT LED LIGHT
*	LED BOLLARD LIGHT
I	LED AREA LIGHT 14' LUMINERE HEIGHT WITH GLARE CUT-OFFS AS REQUIRED TO PREVENT LIGHT FROM SHINING ONTO ADJACENT PROPERTIES

# PLANT LIST

SYMBOL	LATIN NAME/ COMMON NAME	CONTAINER SIZE	QUANTITY	REMARKS	WATER USE
IREES				r	
Ó,	ACER PALMATUM BLOODGOOD JAPANESE MAPLE	24 BOX	28	STANDARD	MEDIUM
• }	ULMUS PARAFOLIA EVESCHEPN ELM	15 GAL	22	STANDARD	MEDIUM
•	GUESCUS SUBER SCORK OVIK	15 GAL	14	CRADINATZ	MEDIUM
	PINIUS CANARIENSIS CANARY ISIAND PINE	15 GAL	16	STANDARD	LOW
• }	QUERCUS LOBATA VALLEY OAK	15 GAL	21	STANDARD	tow
5	LAGERSTROEMIA INDICA FIREBIRD <sup>*</sup> RED FLOWERING CRAPE MYRTLE	24' BOX	28	STANDARD	row
2	LAGERSTROEMIA INDICA TUSCAKORA TUSCARORA CRAPE MYRTLE	24° BOX	34	STAHIDARD	row
3	PISTACHIA CHINENSIS KETIH DAVEY KITH DAVIES CHINESE PISTACHE	15 GAL	13	STANDARD	row
•	SURFICUS COCCINEA SCAULETT CAX	15 GAL	16	STANDARD	MEDIJM
3	OSMANTHUS FRAGRANS SWEET CLIVE	24' ROX	31	STANDARD	WEDRIN
3	WASHINGTONIA ROBUSTA MEXICAN FAN PAUM	12 HEIGHT		STANDARD	MEDIUM
5HRUBS		_			
$\odot$	VIBURNUM TINUS SPRING BOUQUET SPRING BOUQUET VIBURNUM	5 GAI	44		MEDIUM
8	CAMELLIA SASANGUA CIEOPATRA	5 GAL	53		MED:UM
0	SASANGUA CAMELUA ROSA NOATRUM	1 GAL	82		MEDIUM
	GROUNDCOVER ROSE (RED) RHAPHIOLEPIS INDICA SPRINGTIME	5 OAL	156		MEDIUM
•	SPRINGTIME INDIA HAWTHORN AGAPANTHUS AFRICANUS 'QUEEN ANNE'	I GAL	384		MEDIUM
*	ULY-OF-THE-NILE DIETES BICOLOR	1 GAL	508		LOW
_	FORTNIGHT LILY/MORREA LILY FOROCAPULI M. MAKT	5 GAL	50		
⊗ ⊚	NANDANA DOMESTICA "COMPICTA" COMPICTI HEAVELEY BAZZECO	1 GAL	196		LOW
0	LOROPÉTALUM CHINENSE JAZZ HANDS' COMPACT LOROPÉTALUM	5 GAL	326		MEDNUM
*	HEMEROCALUS HYBRID EVERGREEN DAYDULY (FLOWER COLOR PER OWNER)	1 GAL	136		MEDIUM
(a)	PHOTINIA X FRASERI FRASERS PHOTINIA	5 GAL	65		MUKDSM
	PRUNUS LAUROCERASUS ENGLISH LAUREL	5 GAL	53		WEDINW
ŏ	GREVILLEA X TNOELL' NOELL GREVILLEA	5 GAL	69		LOW
	ARCTOSTAPHYLOS 'HOWARD MCMINN' MCMINN MANZANITA	5 GAL	78		row
	PLUMBAGO AURKULATA CAPE PLUMBAGO	5 GAL	12		LOW
Ø	ZAUSCHNERIA CALIFORNICA	1 GAL	22		LOW
<u>₩</u> £	CALIFORNIA FUCHSIA MUHLENBERGIA RIGENS	I GAL	18		LOW
	DEER GRASS  CERCIS OCCIDENTALIS  WESTERN REDBUD	5 GAL	12		fOM
	TURF DWARF TURF TYPE TALL FESCUE	SOD	5,012 SF		нюн
m	DWARF TURF TYPE TALL FESCUE TRACHELDSPERMUM JASMINICIDES STAR JASMINE	I GAL	17,887 SF	PLANT @ 36" O.C.	MEDRUM
	TEUCRIUM CHAMAEDRYS 'PROSTRATUM' PROSTRATE GERMANDER	1 GAL	2,041 SF	PLANT @ 36" O.C.	LOW
	PROSTRATE GERMANDER JUNIPERUS CONFERTA SHOPE BUNPER	1 GAL	13,136 SF	PLANT @ 36° O.C	LOW
	SHORE JUNIPER ATTOSTAL HILLOS LIVA LIRSI WOOD'S COMPACT WOOD'S COMPACT GROUNDOOVER MANZANITA	1 GAL	20,034 SF	PLANT @ 36° O.C.	MEDRUM
VINES					
WHES	PARTHENOCISSUS TRICSPIDATA BOSTON IVY	) GAL	10	TRAIN 10 TRASH ENCLOSURE	MEDIUM

### PLAN LEGEND

SYMBOL	DESCRIPTION
0	ENTRY GATE
2	SIX FOOT HIGH, BLACK, TUBULAR STEEL FENCING
3	SIX FOOT HIGH, BOARD ON BOARD FENCE WITH CAP
4	POOL FENCING
3	SHADE TRELUS
<b>6</b>	GUEST BICYCLE PARKING, TYPICAL SYMBOL
0	PG & E ACCESS GATES (12 FOOT MINIMUM WIDTH)
8	TRANSFORMER LOCATION
9	TRASH ENCLOSURE (BY OTHERS)
0	CONCRETE WALKWAY
Û	ASPHALT WALKWAY
0	DOGGIE WASTE STATION
(3	SITE FURNISHING. PER OWNER
<b>(</b> 3	EMERGENCY ACCESS GATE BY OTHERS
<b>(3</b> )	CONCRETE SEATWALL WITH PLANTING CONTAINERS. FORM BOARD FINIS
0	HVACZ UTILITY SCREEN PANEL TYPCIAL AT ALL HVACS/ UTILITIES FACING PLIBLIC VIEW.

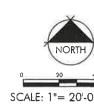

BRIAN FIRTH
LANDSCAPE
ARCHITECT, INC.
GENERAL STREET STREET
CHICC. CALIFORNIA 95928
PHONE (530) 699 1130

WWW.BFLANHISH. COM.
WWW. BFLANHISH. COM.
WWW. Forebook. Com/BFLANHISH.



CONSULTANT

CLIENT

CHANNEL PROPERTIES

1850 SOSCOL AVENUE, SUITE 207 NAPA, CA 94559

PROJECT

EATON RANCH APARTMENTS

EATON AVENUE CHICO CA 95928

SHEET TITLE
EATON RANCH I
PRELIMINARY
LANDSCAPE PLAN
20 SCALE

DATES
NO DESCRIPTION DAT
I REVIEW SUBMITTAL 9-19-1
SITE REVISIONS 10-30-1

Ploi Dale: Oclober 30, 2018 - 2:32 pm

PROJECT NUMBERS
BFIA PROJECT #: 2056
CONSULTANT PROJECT #:
APN: 016-200-117 AND 016-340-034

SHEET NUMBER

L-0.3

• #Attachment H

E: 1"= 20'-0"

OCT 31 2018

# LIGHTING SYMBOLS

_		THE STIME CES				
	SYMBOL	DESCRIPTION				
	۵	CARPORT LED LIGHT				
	*	LED BOLLARD LIGHT				
	Î	LED AREA LIGHT 14' LUMINERE HEIGHT WITH GLARE CUT-OFFS AS REQUIRED TO PREVENT LIGHT FROM SHINING ONTO ADJACENT PROPERTIES				

# PLANT LIST

	SYMBOL	LIVI LIVI	CONTADER	QUANTITY	REMARKS	WATER USE
	TREES	COMMON NAME	SIZE	GOTTHIT	Enterio	
	2	ACER PALMATUM BLOODGOOD	24' BOX	28	STANDARD	MEDIUM
1		SAPANESE MAPLE ULULUS PARVIFOLIA	15 GAL	22	STANDARD	MEDIJM
3	2	TVERGREEN EUN				
\$		GUERCUE SUBER	15 GAL	14	CIANDANIZ	MEDIUM
3	7	PINUS CANARIENSIS	15 GAL	16	STANDARD	LOW
5	JES.	CANARY ISLAND PINE				
T.	. }	QUERCUS LOBATA VALLEY OAK	15 GAL	21	STANDARD	tow
3	1	LAGERSTROEMIA INDICA FIREBIRD	24° 6OX	28	STANDARD	row
34	$\times$	RED FLOWERING CRAPE MYRTLE  LAGERSTROEMIA INDICA 'TUSCARORA' TUSCARORA	24'BOX	34		10
ρĴ	3	CRAPE MYRTLE	15 GAL	13	STANDARD	LOW
Ę	- 5	HISTACHIA CHINENSIS KEITH DAVEY KETH DAWES CHINESE PISTACHE	1504	13	STANDARO	low
1	~	GUERCUS COCCHIEA SCARLETT CARE	15 GAL	16	STANDARD	MED:UM
1	2	position				
	(3)	OSMANTHUS FRAGRANS SWEET OLIVE	24° BOX	3)	STANDARD	MEDIUM
45	10	WASHINGTONIA ROBUSTA			(Turnin	
144	10	MEXICAN FAIN PAIM	12 HEIGHT	.4	STANDARD	MEDIUM
	SHRUBS			-		
	0	VIBURNUM TINUS SPRING BOUQUET SPRING BOUQUET VIBURNUM	5 GAL	44		MEDIUM
	(3)	CAMELLIA SASANGUA 'CLEOPATRA SASANGUA CAMELLIA	5 GAL	53		MECHUM
	0	ROSA NOATRUM GROUNDCOVER ROSE (RED)	1 GAL	82		MEDIUM
	0	RHAPHIOLEPIS INDICA 'SPRINGTIME' SPRINGTIME INDIA HAWTHORN	5 GAL	156		MEDIUM
	*	AGAPANTHUS AFRICANUS 'QUEEN ANNE' ULY OF THE NILE	1 GAL	384		MEDIUM
	*	DIETES BICOLOR FORTNIGHT LILY/MORREA LILY	I GAL	508		LOW
	⊗	PODOCARPUS M. MAKI SHRUBBY YEW PINE	5 GAL	50		MEDILIM
	•	NANDINA DOMESTICA "COMPACTA" COMPACT HEAVENLY DAMBOO	1 GAL	196		row
	0	LOROPETALUM CHINENSE JAZZ HANDS	5 GAL	326		MEDIUM
		COMPACT LOROPETALUM HEMEROCALUS HYBRID	1 GAL	136		MEDIUM
	(4)	EVERGREEN DAYDLILY (FLOWER COLOR PER OWNER) PHOTINIA X FRASERI	5 GAL	65		MEDIUM
	X	FRASERS PHOTINIA PRUNUS LAUROCERASUS	5 GAL	53		MEDIUM
\	1	ENGLISH LAUREL GREVILLEA X NOSLL'	5 GAL	69		row
J	0	NOELL GREVILLEA ARCTOSTAPHYLOS HOWARD MCMINNI	5 GAL	8		LOW
6		MCMINN MANZANITA PLUMBAGO AURKULATA	5 GAL	12		
2		CAPE PLUMBAGO ZAUSCHNERIA CAUFORNICA	1 GAL	22		TOW
	Ø	CALIFORNIA FUCHSIA MUHLENBERGIA RIGENS	1 GAL	18		FOM
		DEER GRASS CERCIS OCCIDENTALIS	5 GAL	12		row.
		WESTERN REDRUD				
		TURF DWARF TURF TYPE TALL FESCUE TRACHEL CORPORATION ASSUMPTIONS	SOD	5,012 SF	NAME OF A STATE OF A S	HIGH
		TRACHELOSPERMIJM JASMINOIDES STAR JASMINE TEUCRIUM CHAMAEDRYS PROSTRATUM:	I GAL	17,887 SF 2,041 SF	PIANT @ 36' O.C.	LOW
	ACCEPT.	PROSTRATE GERMANDER	1 GAL	13,130 SF	PLANT @ 36' O.C.	LOW
		JUNIPPERUS CONFERTA SHORE JUNIPER  APPOSTAGENY LOS LIME LINES WOODS COMPACT			PLANT @ 36' O.C.	
	F	ARTOSTAPHYLOS LIVA URSI WOODS COMPACT WOODS COMPACT GROUNDCOVER MANZANITA	l GAL	20,034 SF	LOWING 39, C.C.	MUNDEM
	VINES:	PARTHENOCISSUS TRICSPIDATA	1.54	10	TRAIN TO	MEDIUM
		BOSTON IV	1 GAL		Trash Enclosure	
	4	TRACHELOSPERMUM JASMINONDES STAR JASMINE (STAKED)	1 GAL	36	TRAIN HVAC SCREEN	MEDIUM

## PLAN LEGEND

SYMBOL	DESCRIPTION
0	ENTRY GATE
2	SIX FOOT HIGH, BLACK, TUBULAR STEEL FENCING
3	SIX FOOT HIGH, BOARD ON BOARD FENCE WITH CAP
4	POOL FENCING
(3)	SHADE TRELLIS
6	GUEST BICYCLE PARKING TYPICAL SYMBOL
0	PG & E ACCESS GATES (12 FOOT MINIMUM WIDTH)
8	TRANSFORMER LOCATION
9	TRASH ENCLOSURE (BY OTHERS)
0	CONCRETE WALKWAY
0	ASPHALT WALKWAY
0	DOGGIE WASTE STATION
(3)	SITE FURNISHING, PER OWNER
<b>(</b> 4)	EMERGENCY ACCESS GATE, BY OTHERS
(3)	CONCRETE SEATWALL WITH PLANTING CONTAINERS, FORM BOARD FINISH
0	HVAC/ UTILITY SCREEN PANEL TYPCIAL AT ALL HVACS/ UTILITIES FACING PUBLIC VIEW



BRIAN FIRTH LANDSCAPE
ARCHITECT, INC.
627 BROADWAY, SUITE 220,
CHICO, CALIFORNIA 95928 PHONE (530) 899 1130

LICENSE

CONSULTANT

CHANNEL **PROPERTIES** 

1850 SOSCOL **AVENUE, SUITE 207** NAPA, CA 94559

EATON RANCH **APARTMENTS** 

EATON AVENUE CHICO CA 95928

SHEET TITLE EATON RANCH I PRELIMINARY LANDSCAPE PLAN 20 SCALE

DATES
NO DESCRIPTION DATE
1 REVIEW SUBMITTAL
SITE REVISIONS 10-30-18

Plot Date: October 30, 2018 - 2:32 pm

PROJECT NUMBERS BFLA PROJECT # 2056 CONSULTANT PROJECT #: APN: 016-200-117 AND 016-340-034

SHEET NUMBER

L-0.4

• Attachment H










STATION




BRIAN FIRTH LANDSCAPE ARCHITECT, INC 627 BROADWAY, SUITE 220. CHICO, CALIFORNIA 95928 LICENSE

CONSULTANT



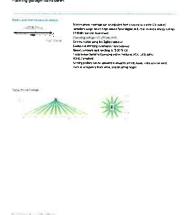



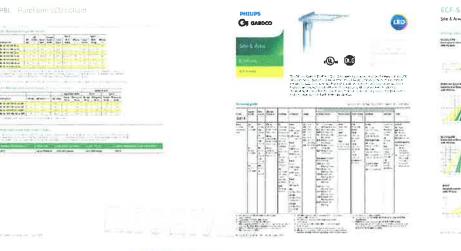

CHANNEL **PROPERTIES** 1850 SOSCOL **AVENUE, SUITE 207** NAPA, CA 94559 EATON RANCH **APARTMENTS** 

CARPORT

**BOLLARD LIGHT** 

OCT 31 2018 AREA LIGHT (14 FOOT LUMINERE HEIGHT)

SHEET TITLE
EATON RANCH I
PRELIMINARY DESIGN DEVELOPMENT

EATON AVENUE

CHICO CA 95928

DAT	FC	
NO	DESCRIPTION	D
7	REVIEW SUBMITTAL	9-19





BOARD ON BOARD FENCE



POOL FENCING




**ENTRY SIGNAGE** 

PROJECT NUMBERS BFLA PROJECT #: 2056 CONSULTANT PROJECT #:

SHEET NUMBER

L-0.5



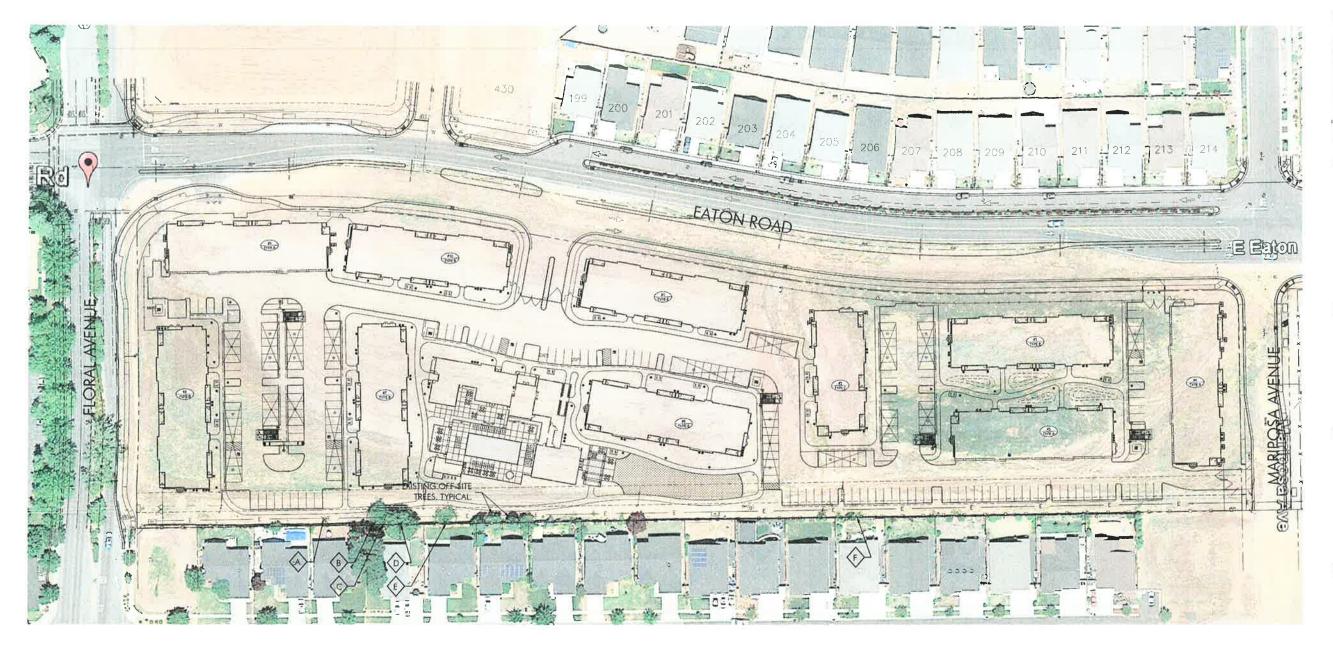

# TREE MITIGATION TABLE


TREE ID NUMBER	TREE SPECIES	DIAMETER (DBH)	REMOVE/ RETAIN	MITIGATION REQUIREMENT	REMARKS
$\Diamond$	VALLEY OAK	1-1/2", 1-1/2", & 2"	REMOVE	NO	LESS THAN 6" DBH
B	CHINESE WINGNUT	18", 12" & 8"	REMOVE	YES	120° CIRCUMFERENCE
<b>©</b>	CAMPHOR	16°	REMOVE	YES	50" CIRCUMFERENCE
<b>(b)</b>	CHINESE WINGNUT	20" & 20'	REMOVE	YES	126" CIRCUMFERENCE
E	SILKTASSEL TREE	1", 1", 1", 1"1-1/2", 1-1/2", 1-1/2", 2"	REMOVE	МО	LESS THAN 15 FEET HIGH
<b>₽</b>	соттонwood	20" & 20°	REMOVE	NO	NOT A QUALIFYING SPECIES
QUALI	DBH OF FYING TREES TO MOVED	94" DBH			DR "IN-LIEU' FEES FOR 16 ARE REQUIRED

# NOTES

- 1. OBTAIN WRITTEN APPROVAL FROM THE CITY OF CHICO URBAN FORESTER PRIOR TO THE REMOVAL OF ANY TREES.
- 2. ALL TREES TO BE REMOVED ARE WITHIN PG&E'S ACCESS EASEMENT FOR MAINTENANCE OF OVERHEAD POWER LINES. AS SUCH, ADDITIONAL PERMISSIONS MAY BE REQUIRED. CONTRACTOR IS RESPONSIBLE FOR OBTAINING ANY SUCH PERMISSIONS PRIOR TO TREE REMOVAL.

OCT 31 2019

(17) 7 E f 11 p 1/10 Cu qu Cu s

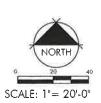

BRIAN FIRTH
LANDSCAPE
ARCHITECT, INC.
627 BROADWAY, 5UITE 220
CHICO, CAIFOZNA 95978
PHO:IE (500) 899 1130

LICENSE



CONSULTANT

CLIE

CHANNEL PROPERTIES

1850 SOSCOL AVENUE, SUITE 207 NAPA, CA 94559

PROJECT

EATON RANCH APARTMENTS

EATON AVENUE CHICO CA 95928

SHEET TITLE
EATON RANCH I
PRELIMINARY TREE
REMOVAL PLAN
ENLARGEMENT

DATES
NO DESCRIPTION DATE
REVIEW SUBMITTAL
SITE REVISIONS 10-30-18

Plot Date: October 30, 2018 - 2:41 pm


PROJECT NUMBERS

BFLA PROJECT # 2056

CONSULTANT PROJECT #

APN: 016-200-117 AND 016-340-03

SHEET NUMBER

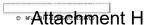





Philips Gardco PureForm LED bollard PBL integrates a sleek, low profile design, extraordinary light output, and energy savings into an innovative pedestrian scale luminaire. PureForm bollard features a high performance optical system designed to achieve wide spacings and full cutoff performance. Three heights available for a customized look. IP66 optics ensure dust or moisture will never interfere with performance.

#### Ordering guide

example: PBL-42-14L-450-NW-G2-5-UNV

Prefix	Shaft Height	Number of LEDs Dr	rive Current	LED Color - Generation	1	Distribution	Emergency		Voltage
PBL		14L							
PBL PureForm t	bollard 36 Standard Shaft 36" 42 Standard Shaft 42" 60 Standard Shaft 60"	14L 14 LEDs (full ring) 10 20 35 45 60 80 10	200mA 50 350mA 50 450mA 600mA	ww-G2 Warm White 70 CRI Gene Nw-G2 Neutral Whi 70 CRI Gene CW-G2 Cool White: 70 CRI Gene WY-G2 Warm Yello 80 CRI Gene AM-G2 Direct Ambe Generation	ration 2 te 4000K, ration 2 5000K, ration 2 v 2700K, eration 2	Type 3 3 Type 3 Type 5 5 Type 5		k for no battery rgency battery <sup>2811</sup>	120 120V 208 208V 240 240V 277 277V 347 347V 480 480V UNV 120-277V (50/60Hz)
Options						11100 - 111			
Dimming controls		Motion sensing	Photo-sensir	ng	Electrical			Finish	
DD 0-10V External dimming (by others) <sup>45</sup> FAWS Field Adjustable <sup>45</sup> SW Interface module for SiteWise <sup>34,56</sup> LLC Wireless controls without PIR sensor <sup>45,6</sup> BL BI-level functionary with motion sensor <sup>417</sup> DynaDimmer: Automatic Profile Dimming <sup>45</sup>		IMRt Integral infrared	d <sup>7/2</sup> PCB Ph	otocontrol Button <sup>9</sup> D	F2 Dor	gle (120, 277, 347V) uble (208, 240, 480 nadian Double Pull 18, 240, 480VAC) °	OVAC) <sup>9</sup>	Textured  BK Black  WH White  BZ Bronze  DGY Dark Gray  MGY Medium Gra	ıy
CS50 Security 50% Dimming, 7 hours Median 50% Dimming, 8 hours CE50 Economy 50% Dimming, 9 hours DA50 All Night 50% Dimming CS30 Security 30% Dimming, 7 hours CM30 Median 30% Dimming, 8 hours		-			SP2 Inc	<b>ection</b> (10kA stand reased 20kA ound Fault Interrup		CC Custom cold	onal (ex: RAL7024) Ir y color chip for
CM50 Media CE50 Econo DA50 All Nig CS30 Securi CM30 Media CE30 Econo	an 50% Dimming, 8 hours omy 50% Dimming, 9 hours ght 50% Dimming ity 30% Dimming, 7 hours	-			SP2 Inc	reased 20kA		color or RAL CC Custom colo (Must suppl	(ex: RAL702 ir y color chip f

- 1. Extended lead times apply. Contact factory for details.
- 2. Not available in 100, 200 or 350mA.
- 3 Available in 120V or 277V only
- 4 Not available with other control options
- 5. Not available with motion sensor.
- 6. Not available with photocontrol.
- 7. Available only with BL dimming control
- 8 Not available with SW, LLC, and CS/CM/CE/DA
- 9. Must specify input voltage
- 10. Available in 120V only.

- 11 Not available in 347 or 480V
- 12. Not available in 100, 200, and 1050mA.
- 13. Not available with SW or LLC
- 14. Not available in 800 and 1050mA



### PHILIPS





# OCT 31 2018

CITY OF CITTO PLANLING SURVICED





Philips Gardco SoftView LED parking garage luminaires feature edge lit technology, providing visual comfort with minimal glare to enhance the user experience. An added uplight feature reduces the cave effect for an increased sense of security. SoftView features multiple optical distributions, lumen packages and mounting options providing you with the ideal solution for your garage lighting needs. Optional emergency battery backup available for path of egress lighting and is integral to the luminaire.

#### Ordering guide

example: SVPG-140L-2100-NW-G2-5M-5-BL-IMRI2-MGY

								Options			
SVPG SVPG SoftView Parking Garage	Number of LEDs 140L 140L 140LEDs (comfort	Drive Current 450 450mA 800	Color Temperature WW-G2 Warm White 3000K (70 CRI)	Mounting  SM Surface / Pendant Mount (pendant	Distribution  IR Type IR Rectangular	Emergency  NONE Leave Blank E8P1327	Voltage 120 120V 208	Dimming controls  NONE Leave Blank DD 990334	Motion sensing NONE Leave Blank	Electrical  Fusing F1" SIngle Fuse	Finish  BZ  Bronze  MGY
	engine)	800mA 1200 1200mA 1675 1675mA 2100 2100mA	Generation 2 NW-G2 Neutral White 4000K (70 CRI) Generation 2 CW-G2 Cool White 5000K (70 CRI) Generation 2 WY-G2 Warm Yellow 2700K (80 CRI) Generation 2 <sup>5</sup> BW-G2 Balanced White 500K (80 CRI) Generation 2 <sup>5</sup>	and function box by others)  T's  Tiunnion  Mount (ordered separately, see Accessories)  WM  Wall Mount (ordered separately, see Accessories)	34 Type III Asymmetric 5 Type V CD Concentrated Downlight	Emergency Battery pack EBPC 1240 In Emergency Battery pack cold rated	208V 240 240V 277 277V UNV Universal 120-277V 347 480 480V HVU Universal 347-480V	O-IOV Dimming external leads (controls by others) BL ***DIM** B'-level with motion sensor LLC ***DIM** Wireless Controls	Integral Motion Response, #2 tens IMRI3º Integral Motion Response, #3 lens (factory customizable, contact factory*)	(120, 277, 347V) F2* Double Fuse (208, 240, 480V) F3* Double Fuse Canadian double pull (208, 240, 480V) Surge Protection blank SPI 10KV 5KA (standard) SP2 20KV 10KA (option)	Medium Gray WH White OC Optional Color Specify optional color or RAL ex: OC-LGP or OC-RAL7024 SC Special Color Mus supply color chip Requires factory quote

- 1 Choose either EBP suitable for 0°C (32°F) to +40°C (+104°F) or EBPC suitable for -20°C (-4°F) to +40°C (+104°F).
- 2 Not available with 347V, 480V or HVU
- $3\,$  Not available with 1200mA, 1675mA or 2100mA  $\,$
- 4 Not available with 2100mA
- 5 Extended lead times apply Contact factory for details.
- 6 Not available with Emergency options (EBP, EBPC)
- 7 Available with **120V**, **208V**, **240V**, **277V** or **UNV** only
- 8. Provide specific input voltage.
- 9 Luminaire includes 0-10V dimming wires for dimming control by others.
- 10.0-10V dimming driver standard
- 11. Must be combined with Motion Sensing option (IMRI2 or IMRI3).
- Must be combined with Dimming Controls option (BL or LLC)
- 13. Not available with Motion Sensing
- 14. Not available with other Dimming Controls.
- 15 Trunnion Mount (T) not available with both DD and EBP or EBPC, is available with each individually (DD or EBP or EPBC).











The Philips Gardco EcoForm Gen-2 combines economy with performance in an LED area luminaire. Capable of delivering up to 26,400 lumens or more in a compact, low profile LED luminaire, EcoForm offers a new level of customer value. EcoForm features an innovative retrofit arm kit, simplifying site conversions to LED by eliminating the need to drill additional holes in most existing poles. Integral control systems available for further energy savings.

#### Ordering guide

example: ECF-S-64L-900-NW-G2-AR-5-120-HIS-MGY

Prefix	Number of LEDs	Drive Current	LED Color - Generation	Mounting	Distribution		Options					
						Voltage	Dimming controls	Motion sensing	Photo-sensing	Electrical	Luminaire	Finish
ECF-S								L				
ECF-S EcoForm site and area, small	32L 32 LEDs (2 modules) 48L 48 LEDs (3 modules) 64L 64 LEDs (4 modules)	700 mA 1A 1050 mA 1.2A 1200 mA 900 900 mA	WW-G2 Warm White 3000K, 70 CRI Generation 2 NW-G2 NW-G2 Cool White 5000K, 70 CRI Generation 2	mounting kits must be ordered separately (See accessories) SF SIsip Fitter Mount <sup>11</sup> (fits to 2½° O D. tenon) WS Wall mount with surface conduit rear entry	Type 2 2 Type 2 2-90 Rotated left 90 2-270 Rotated left 90 3-90 Rotated left 90' 3-270 Rotated left 90' 3-270 Rotated left 90' 3-270 Rotated left 90' 4-70 Rotated left 90' 4-270 Rotated left 90' 4-270 Rotated left 90' 4-80 Rotated left 90'	120 120V 208 208V 240 240V 277 277V 347 347V 480 480V UNV 120-277V (50/60H2)	DD 0-10V External dimming (by others) <sup>5</sup> DCC Dual Circuit Control <sup>6</sup> FAW5 Field Adjustable <sup>14</sup> SW Interface module with #2 lens <sup>18</sup> LLC2 Integral module with #3 lens <sup>18</sup> LLC3 Integral module with #3 lens <sup>18</sup> LLC4 Integral module with #4 lens <sup>18</sup> LLC5 Integral module with #4 lens <sup>18</sup> DynaDImmer: Automatic Profile Dimming CS50 Safety 50% Dimming, 7 hours¹ CM50 Median 50% Dimming, 8 hours¹ CE50 Economy 50% Dimming, 9 hours¹ DA50 All Night 50% Dimming, 7 hours¹ CM30 Safety 30% Dimming, 7 hours¹ CM30 Safety 30% Dimming, 8 hours¹ CE30 Economy 30% Dimming, 8 hours¹ CE30 Economy 30% Dimming, 9 hours¹ DA30 All Night 30% Dimming, 9 hours¹ DA30 All Night 30% Dimming, 9 hours¹ DA30 All Night 30% Dimming, 9 hours¹		PCB Photocontrol Button 23 TLRD5 TLRD5 Twist Lock Receptacle 5 Pin 16 TLRD7 Twist Lock Receptacle 7 Pin 16 TLRPC Twist Lock Receptacle W/Photocell 2	Fusing F1 Single (120, 277, 347VAC) <sup>2</sup> F2 Double (208, 240, 480VAC) <sup>2</sup> Pole Mount Fusing FP1 Single (120, 277, 347VAC) <sup>2</sup> FP2 Double (208, 240, 480VAC) <sup>2</sup> FP3 Canadian Double Pull (208, 240, 480VAC) <sup>2</sup> Surge Protection (10kA standard) SP2 Increased 20kA	Square Pole Adapter included in standard product TB Terminal Block? RPA Round Pole Adapter (fits to 3*- 3.9* O.D. pole)** HIS Internal Housing Side Shield *	Textured  BK Black WH White BZ Bronze DGY Dark Gray MGY Medium Gra Customer specific RAL Specify optional color or RAL (ex: RAL702c CC Custom colo (Must supply color chip for required factory quote

- Available only on 120, 208, 240, and 277 (or UNV)


- Available only on 120, 208, 240, and 277 (or UNV)
  Specify Voltage
  Not available with 347 or 480 voltage
  HIS not available with Type 5 or 5W optics
  DD is required for LLCR, Dimming leads are supplied through back of luminaire Must be ordered separately (See accessories page)
  DCC and LLC2/3/4 not available with any other controls
- TB not available with DCC
- 8 ECF-IMRI equipped with out-boarded sensor housing when voltage is HVU (347-480V)

  Mounts to a 4" round pole with adapter included for


  - square poles


    Not available with SF and WS RPAs provided with black
    finish standard


  - Limited to a maximum of 45 degrees aiming above horizontal SW option is not available with any other control options with the exception of IMRI3, IMRI7 and SW-IMRO motion response options
- Available only on 120V and 277V
   Not available with DCC, IMRI3, IMRI7, SW, LLC and CS/CM/CE/DA (DynaDimmer)
- TLRD5/7 option not available with LLC, PCB, TLRPC or DCC
  Max aiming angle 45' Works with 3 or 5 pin NEMA photocell/dimming
  Dimming will not be connected to NEMA receptacle if ordering with DD, CS/CM/CE/DA, IMRI and IMRO

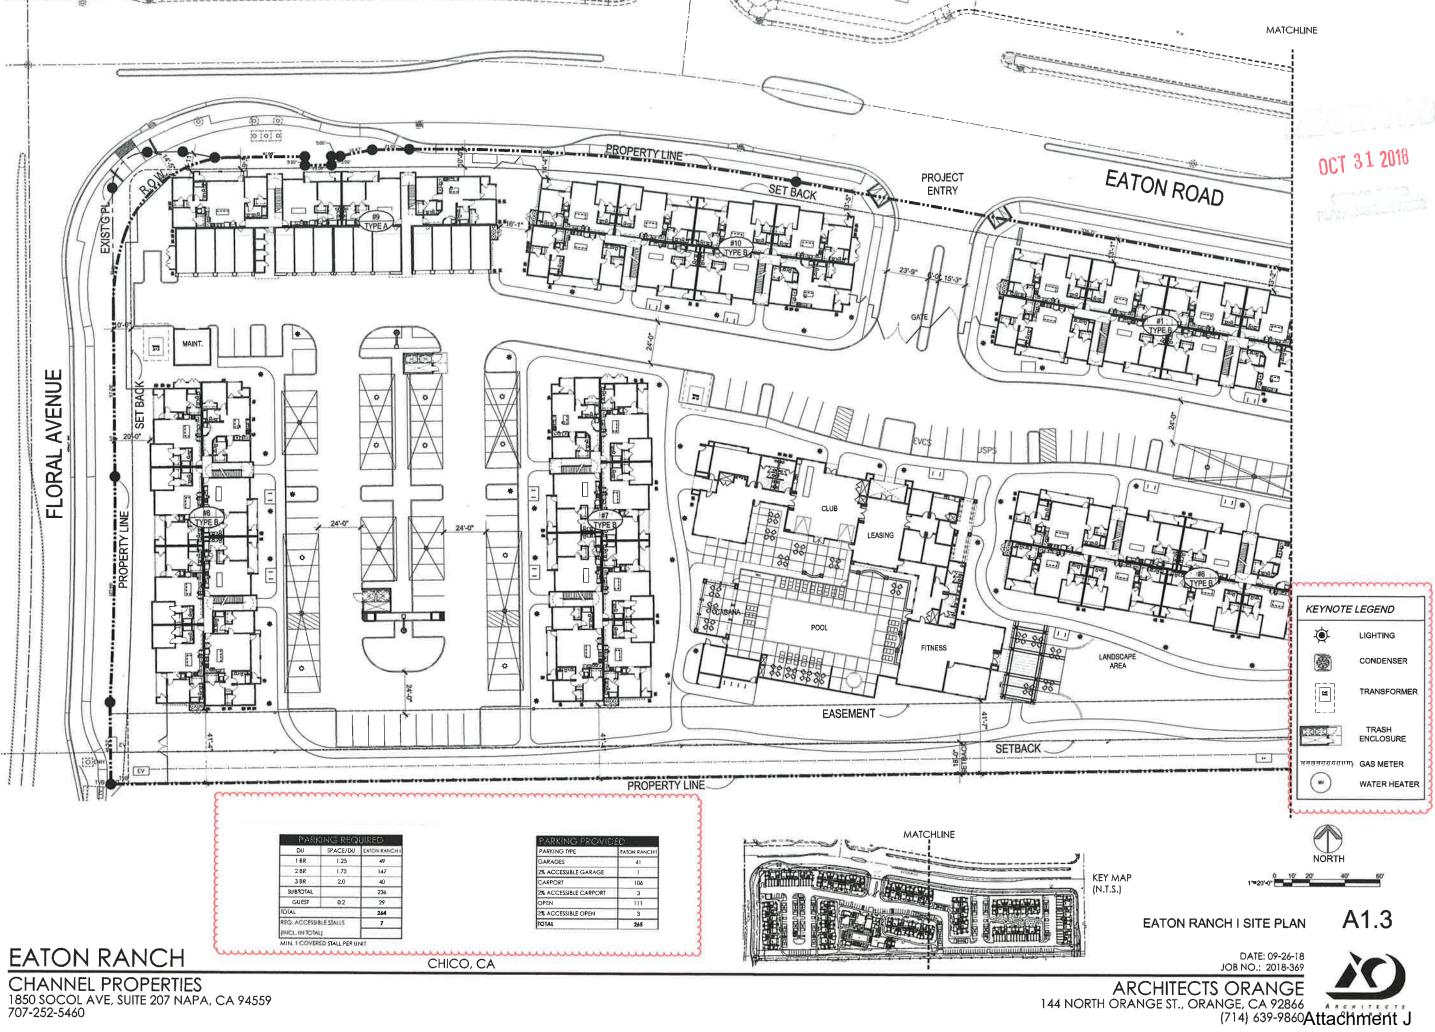

CHANNEL PROPERTIES
1850 SOCOL AVE, SUITE 207 NAPA, CA 94559
707-252-5460

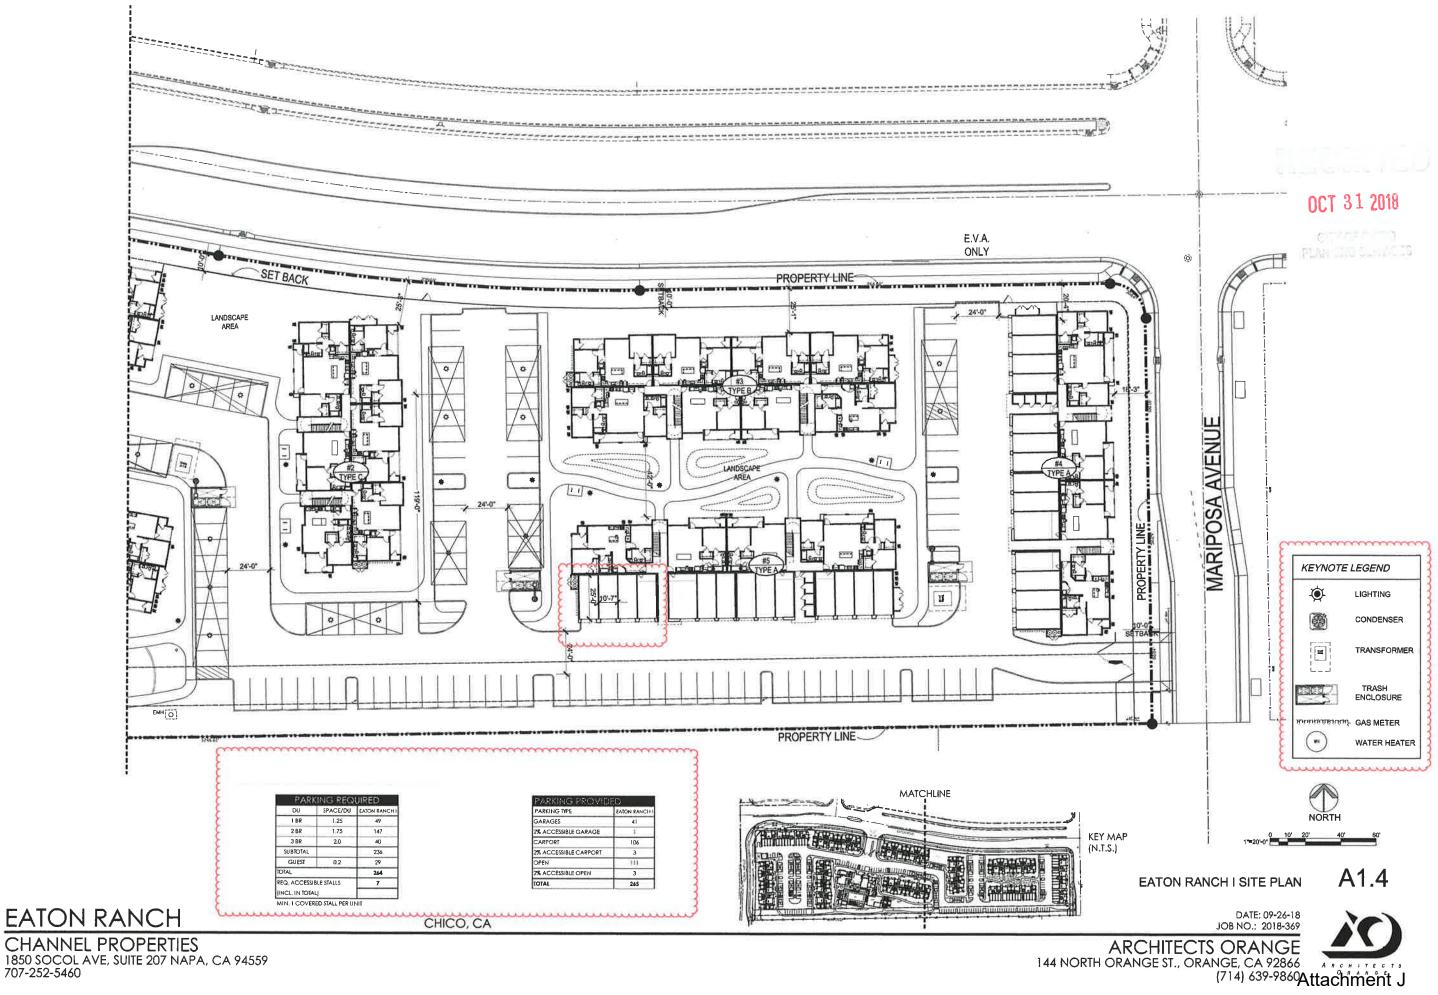

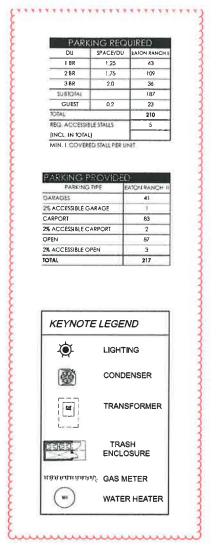

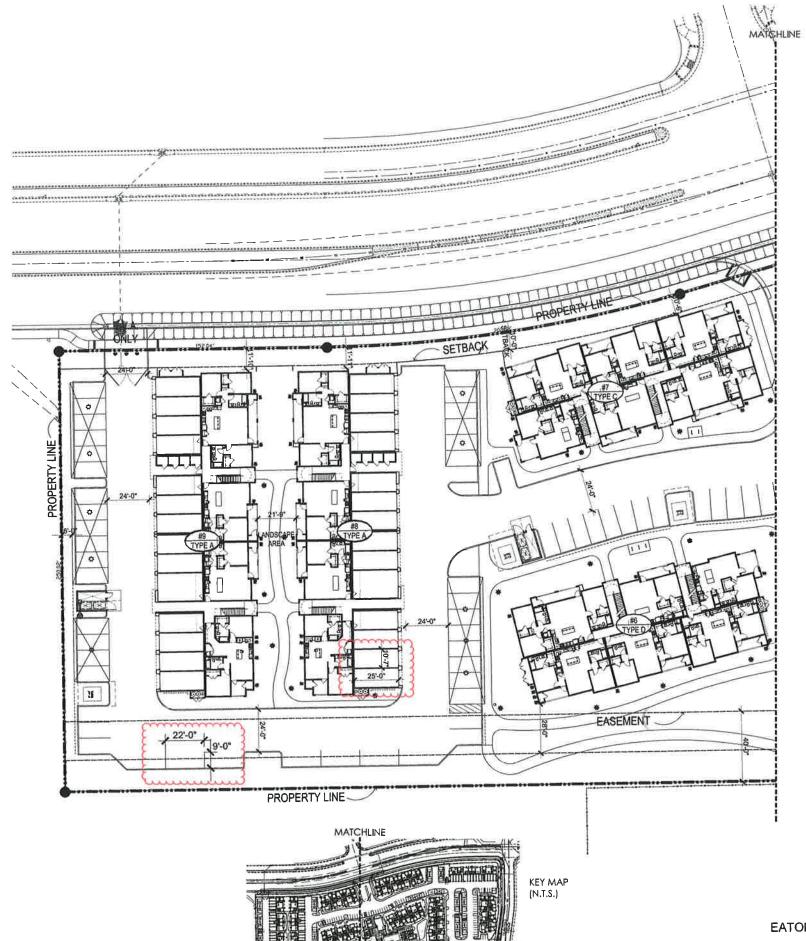



OCT 31 2018

PLANTING SHERIES




EATON RANCH II SITE PLAN

A1.5

**EATON RANCH** 

CHICO, CA

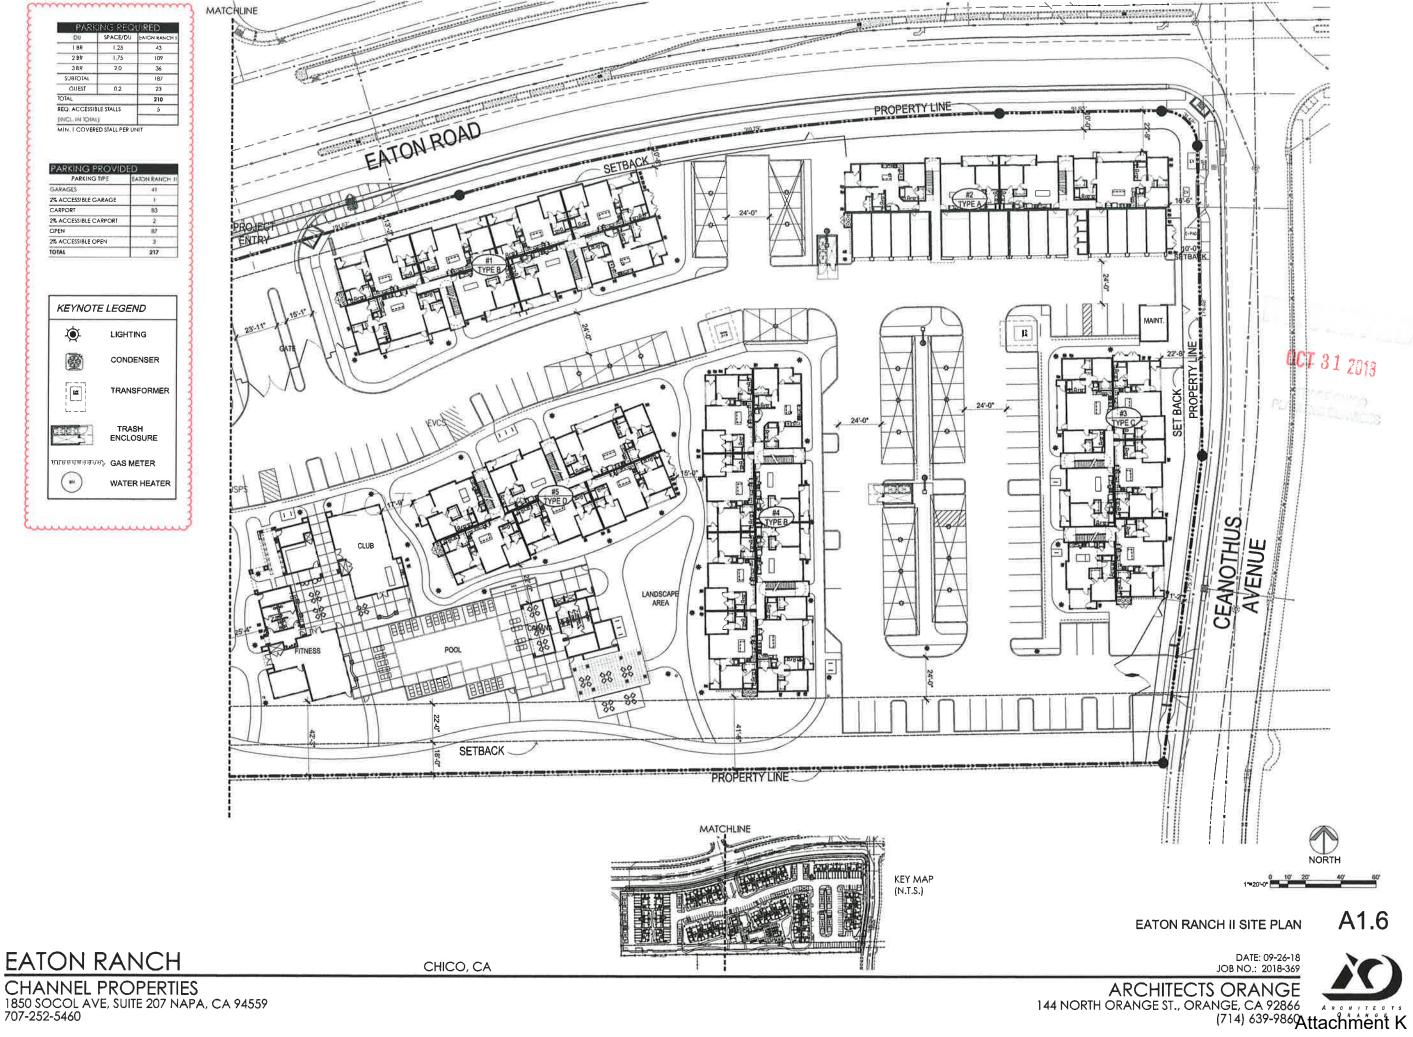

#### **Eaton Ranch I & II Neighborhood Meeting Minutes**

Meeting commenced on time at 5:30 PM on Monday, October 22, 2018. Meeting took place on-site near the corner of Floral Avenue and Eaton Road. In attendance were Jim Mann, Rural Consulting Associates – Project Consultant, Mark R. Funseth, Applicant/Owner's Representative, Wes Gilbert, W. Gilbert Engineering – Project Civil Engineer, Brian Firth, Brian Firth Landscape Architects, Inc. – Project Landscape Architect, Shannon Costa, City of Chico Assistant Planner – Project Planner, and approximately 27 neighboring Residents. Residents who attended filled out their information on the attached Sign-In Sheet. Two people refused to sign-in or provide any contact information.

Jim Mann opened the meeting with an introduction of the Project Team in attendance followed by a brief overview/description of the Project covering the following:

- Owner is Channel Lumber/Channel Properties. Project will be managed by FPI
  Management. Same team developed, owns, and operates Eaton Village Apartments
  which is located on Eaton Road west of Esplanade
- Current zoning/density allows for 14-22 units per acre. Project density as proposed is approximately 16 1/2 units per acre
- Architecture two-story garden style apartments
- Site Main and secondary entry locations at Eaton Road and Mariposa for Eaton Ranch I and Eaton Road and Ceanothus for Eaton Ranch II respectively
- Security Gated community with gates locked after normal business hours
- 24" x 36" site plans, colored architectural renderings, and landscape plans are here on display for Residents to review.

Shannon Costa then gave a brief overview covering the following:

- Purpose of Neighborhood Meeting
- Project Status Application for ARB and Planning under a PD was received by City and Completeness Review is in process
- Neighboring residents will be notified at least 10 days in advance of future ARB and Planning Commission public hearings
- Zoning Land is zoned R-3 which allows for multi-family residential use with a density of 14 to 22 units per acre

Meeting was then opened up to questions from Residents. The following items were discussed during this part of the meeting:

 Zoning – Resident who resides in the neighborhood to the South claimed that they were told when they bought their house that this land would always be Open Space.
 Shannon Costa replied saying that she did not recall what the zoning was before the

#### Page 2 of 3

- current zoning which has been in place since approximately 2007 when the Mountain
  Vista and Sycamore Glen Planned Development Permits were approved. She also stated
  that she doubted that the site was ever zoned as Open Space. Other residents remarked
  that they did not know what zoning was designated for this site. However, one Resident
  indicated that when they bought their homes, the Project's current zoning was disclosed
  to them in writing by Seller/Developer, Epick Homes.
- Off-site Improvements Resident asked if there were any signal lights or roundabouts being proposed. Project Team responded saying that Eaton Road would be expanded to two lanes in each direction with a center median and cuts as shown on the site plan. No signal lights are being proposed but the City has future plans to install roundabouts at Eaton/Floral and Eaton/Ceanothus.
- Fencing and Screening Several neighbors inquired about fencing and screening at the along the southern property line. Project Team responded saying that a 6' board on board fence would be installed just inside the existing wood fence. All buildings are setback at least 40' from the southern property line and are orientated in such a way to minimize second story units "looking into the backyards of neighboring residents". Brian Firth then elaborated on landscaping proposed in this 40' setback area to help screen the Project. He also reminded Residents that certain restrictions imposed by PG&E limit the height and type of trees that can be planted in this area.
- Lighting Several Residents inquired about Project lighting. Specifically, at the southern
  portion of the Project. Project Team responded saying LED walkway bollard lights,
  carport lights and 14' tall area lights are proposed in conformance with City Code. A
  couple of Residents indicated there is a transient/homeless problem and wanted more
  lighting, not less to deter this.
- Height of Buildings Several Residents asked about the height of the buildings. Project Team responded saying that most buildings are two stories at a height of approximately 34'. Maximum allowable building height of 45' was noted.

The Meeting then broke up into smaller groups with the following questions being addressed by various Project Team members accordingly:

Will the PG&E easement be fenced or gated?

Regarding the ends of the buildings facing existing homes, will the new apartment residents be able to see out to the existing homes? Are the entrances on the ends of the buildings?

Will the project include new trees?

What size will the trees be in the PG&E easement?

What type of trees will be in the PG&E easement?

### Page 3 of 3

How wide is the PG&E easement?

What height will the fence be?

*Is Mariposa going to connect to Eaton Road?* 

Is Eaton Road going to connect to the East?

Are the apartment units low income?

What is the zoning of the land to the East of Eaton Ranch II?

What about our gates in the existing fence that we use to exit our yards?

With only a few Residents still left in attendance, the meeting ended at approximately 6:15 PM.

Contributors to the Neighborhood Meeting Minutes:

Mark Funseth

Brian Firth

Wes Gilbert

Jim Mann